DEVELOPMENT APPLICATION

DRAWING SCHEDULE

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A01

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A09

- SITE ANALYSIS PLAN
- DEMOLITION PLAN
- PROPOSED SITE PLAN 03 04
- PROPOSED GROUND FLOOR PLAN PROPOSED ROOF PLAN
- SOUTH AND WEST ELEVATION
- 06 NORTH AND EAST ELEVATION 07
 - SECTION VIEW
 - FRONT FENCE DETAILS
- SCHEDULE OF EXTERNAL MATERIALS, COLOURS AND FINISHES
 - SHADOW DIAGRAMS 9AM 23rd SEPTEMBER
 - SHADOW DIAGRAMS 10AM 23rd SEPTEMBER
 - SHADOW DIAGRAMS 11AM 23rd SEPTEMBER
 - SHADOW DIAGRAMS 12PM 23rd SEPTEMBER
 - SHADOW DIAGRAM 1PM 23rd SEPTEMBER
 - SHADOW DIAGRAM 2PM 23rd SEPTEMBER SHADOW DIAGRAM 3PM - 23rd SEPTEMBER
 - SHADOW DIAGRAM 4PM 23rd SEPTEMBER
 - SHADOW DIAGRAM 5PM 23rd SEPTEMBER
 - 19 20 LANDSCAPE AREA CALCULATION SHEET
 - GROSS FLOOR AREA CALCULATION SHEET
 - BASIX COMMITMENTS
 - NATHERS COMMITMENTS
 - 3D VIEWS

ISSUE DETAILS

A 21.09.2023 ISSUED FOR DEVELOPMENT APPLICATION

ADDITIONAL INFORMATION DA

OWNER'S CONSENT FORM

BASIX & NATHERS CERTIFICATION

WASTE MANAGEMENT PLAN

NEIGHBOURS NOTIFICATION PLAN

COST SUMMARY REPORT

STATEMENT OF ENVIRONMENTAL EFFECTS

SURVEY PLAN

STORMWATER PLAN

LANDSCAPE PLAN

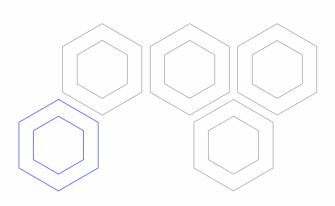


10 ACCREDITED BUILDING DESIGNER

NEW DWELLING - SINGLE STOREY

133 HIGHCLERE AVENUE, PUNCHBOWL NSW 2196

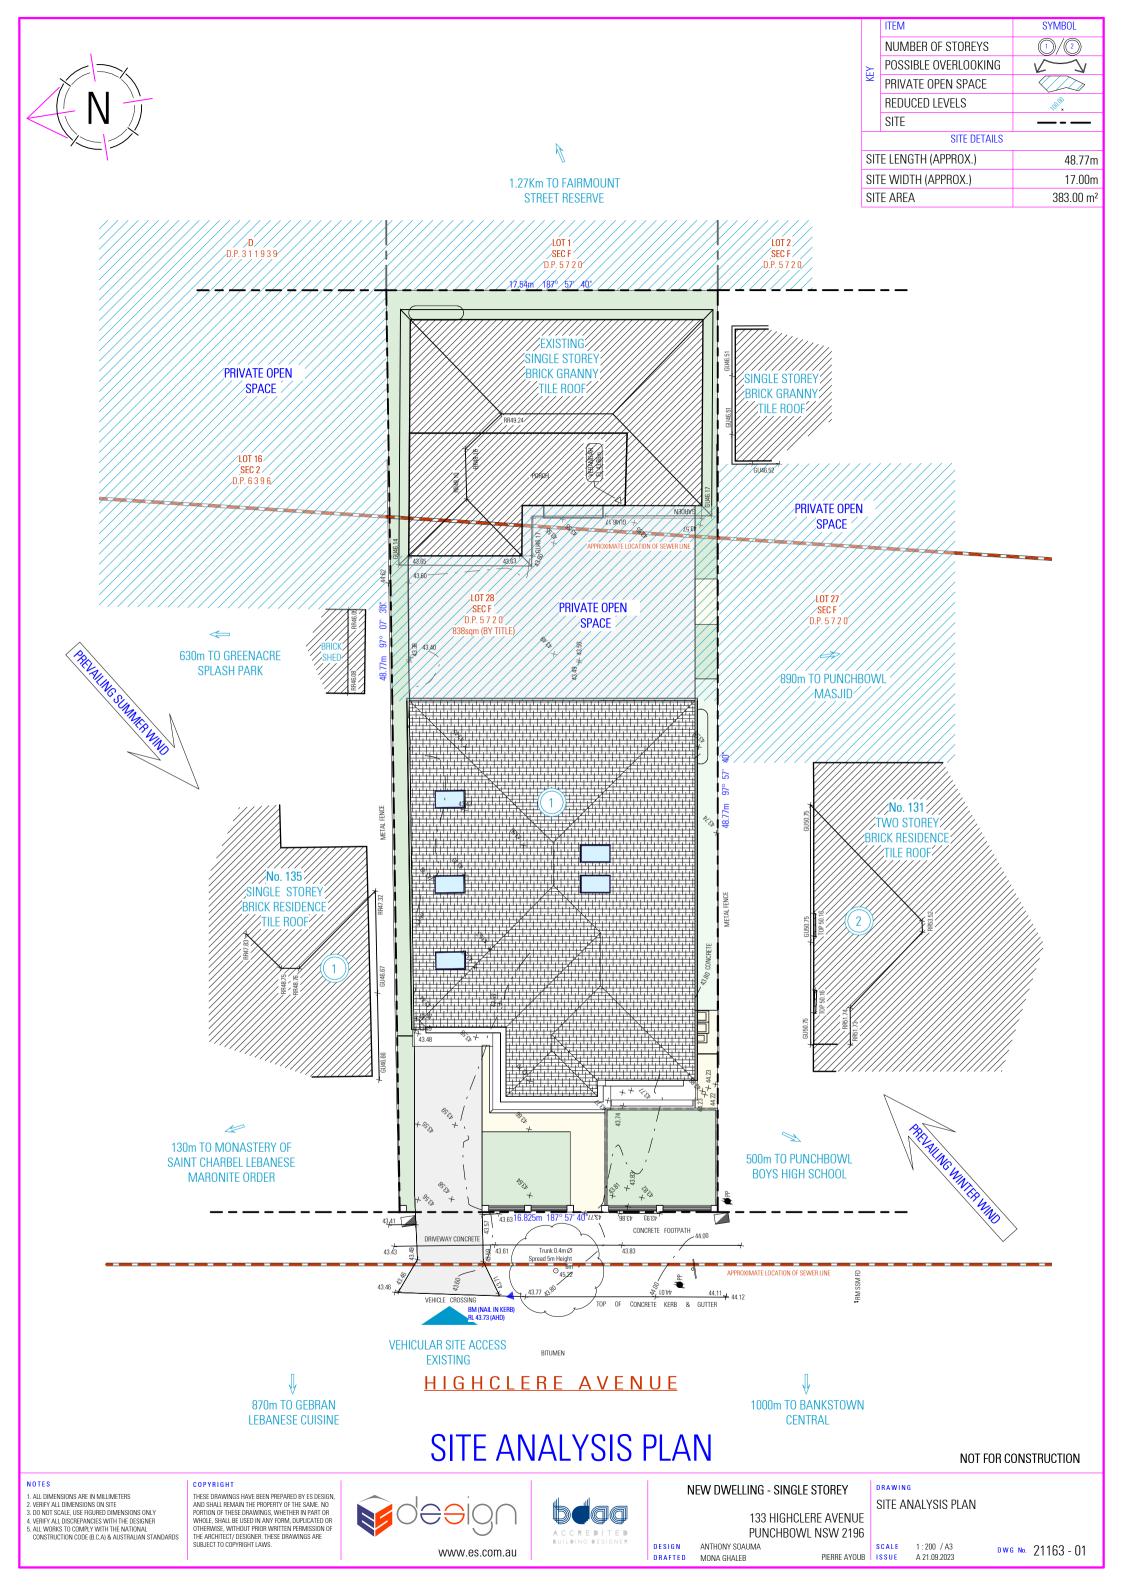
PIERRE AYOUB

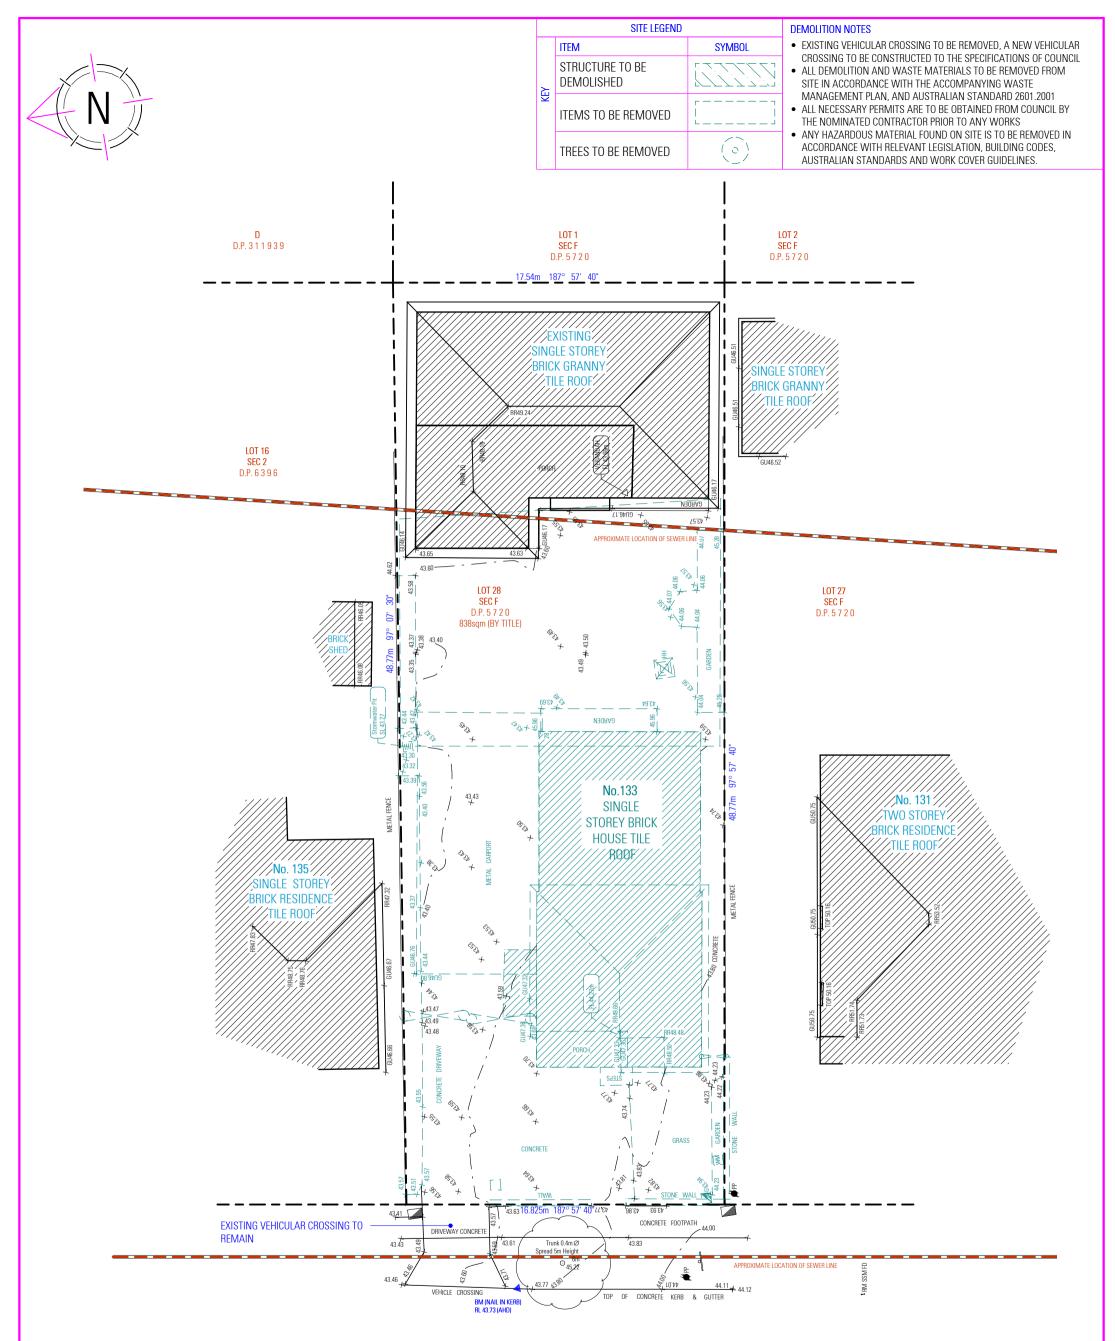






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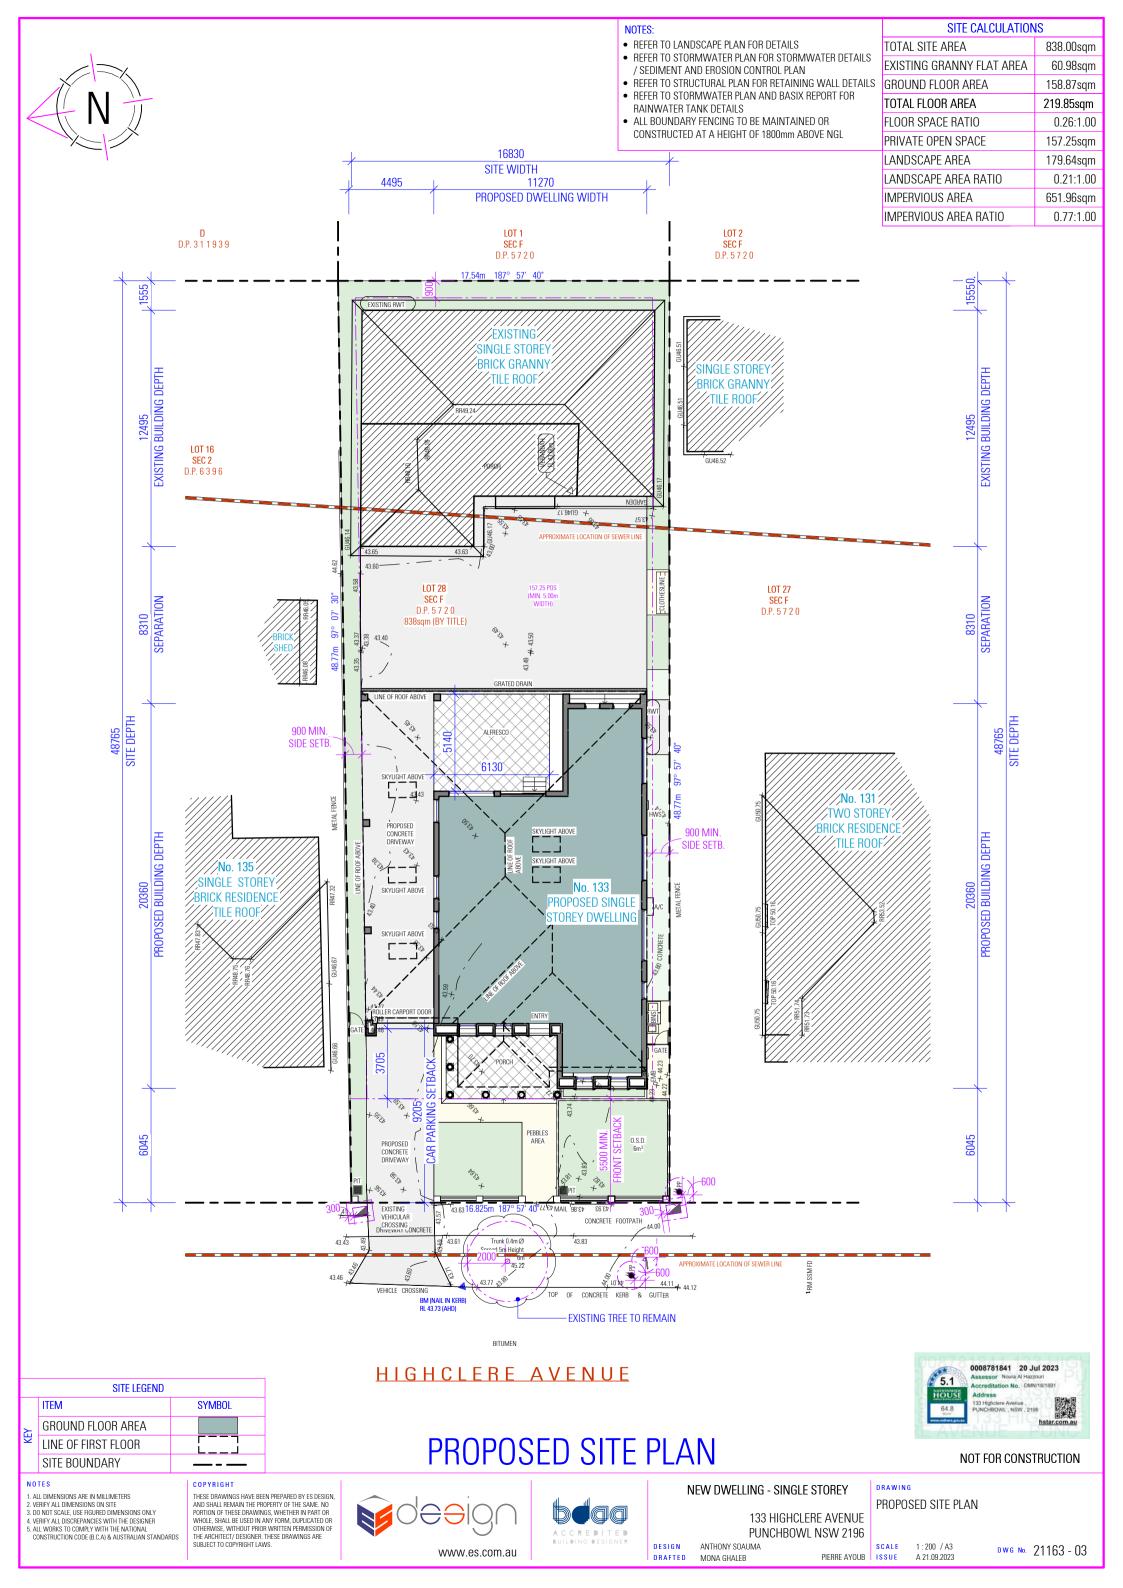


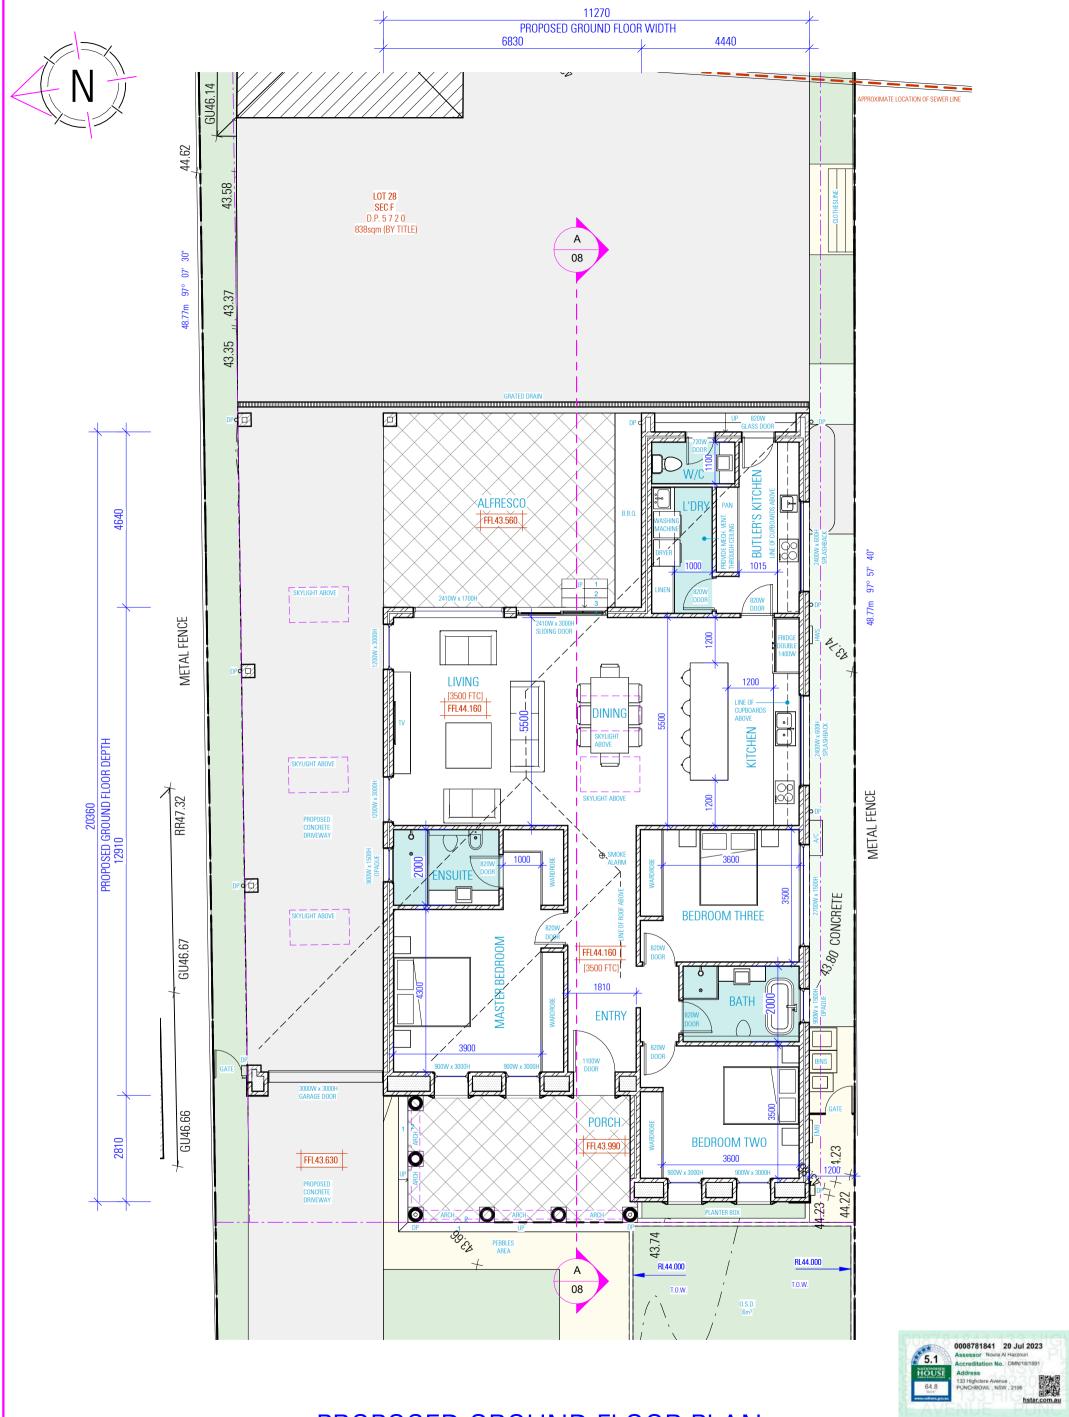
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DEMOLITION PLAN

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PROPOSED GROUND FLOOR PLAN

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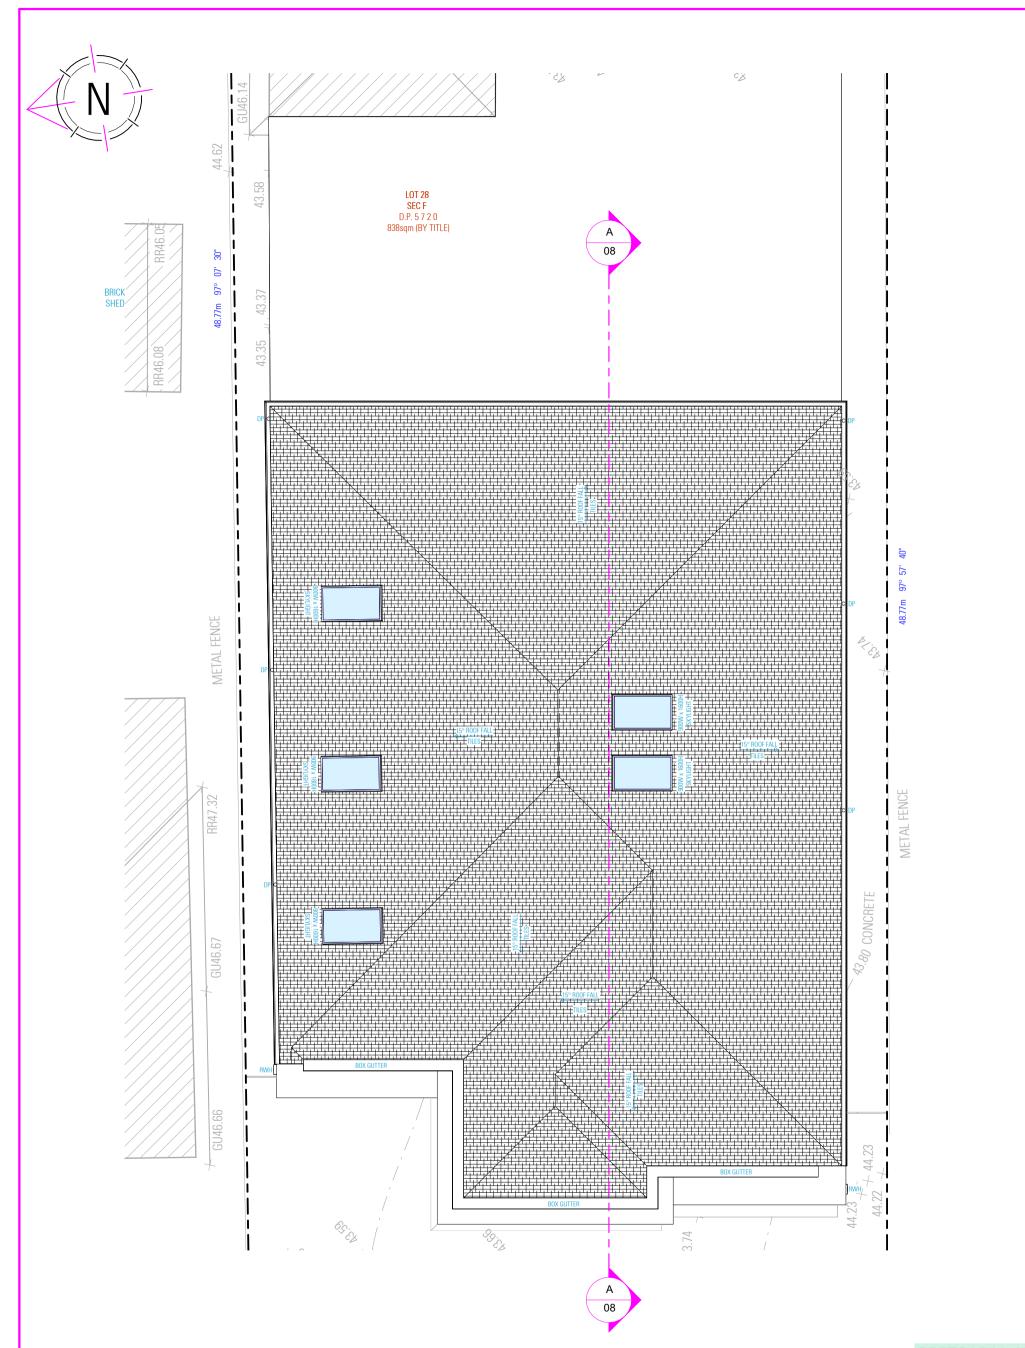
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	ANTHONY SOAUMA	SCALE
)	MONA GHALEB PIERRE AYOUB	ISSUE

PROPOSED GROUND FLOOR PLAN

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PROPOSED ROOF PLAN

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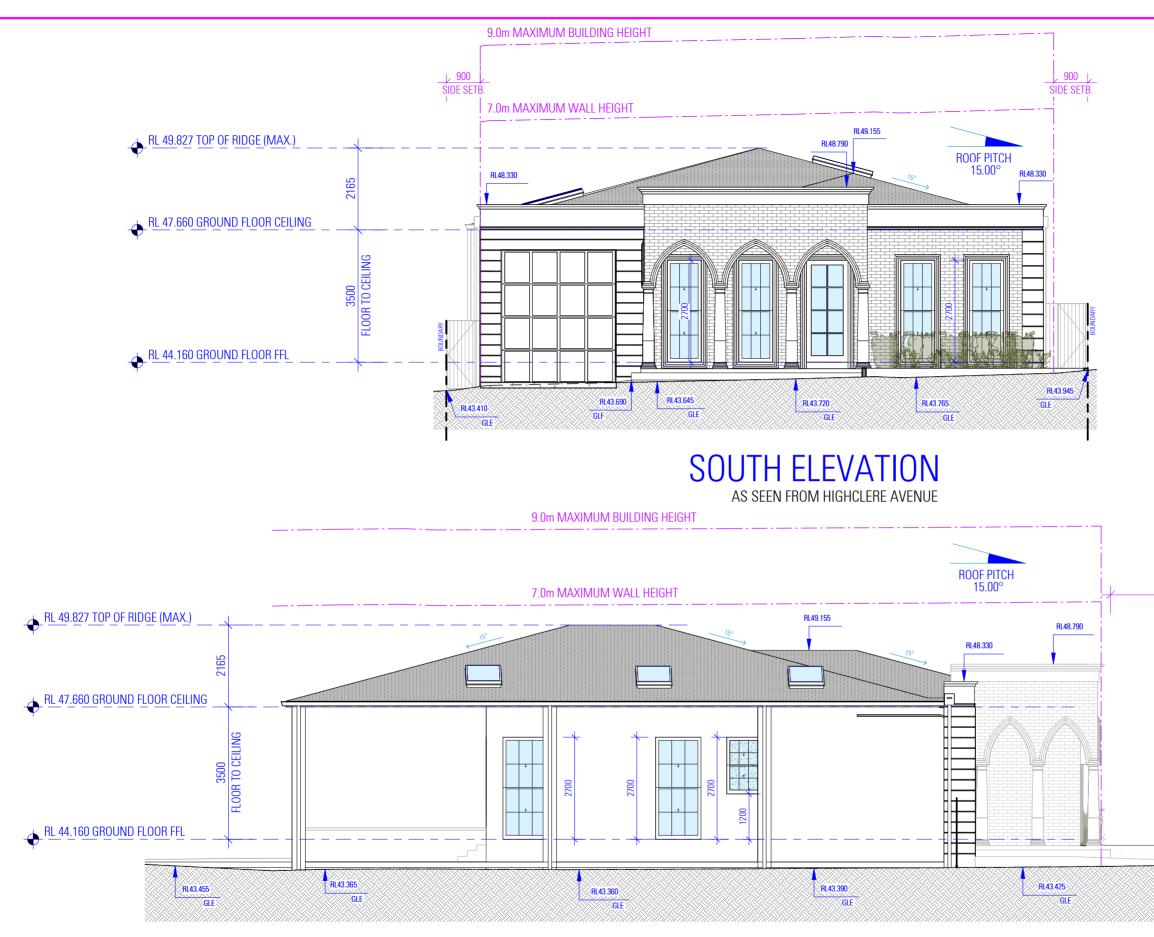
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WEST ELEVATION

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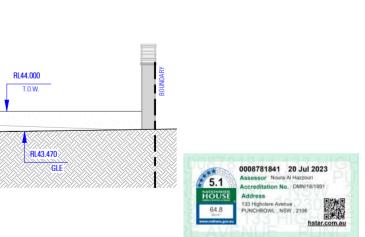
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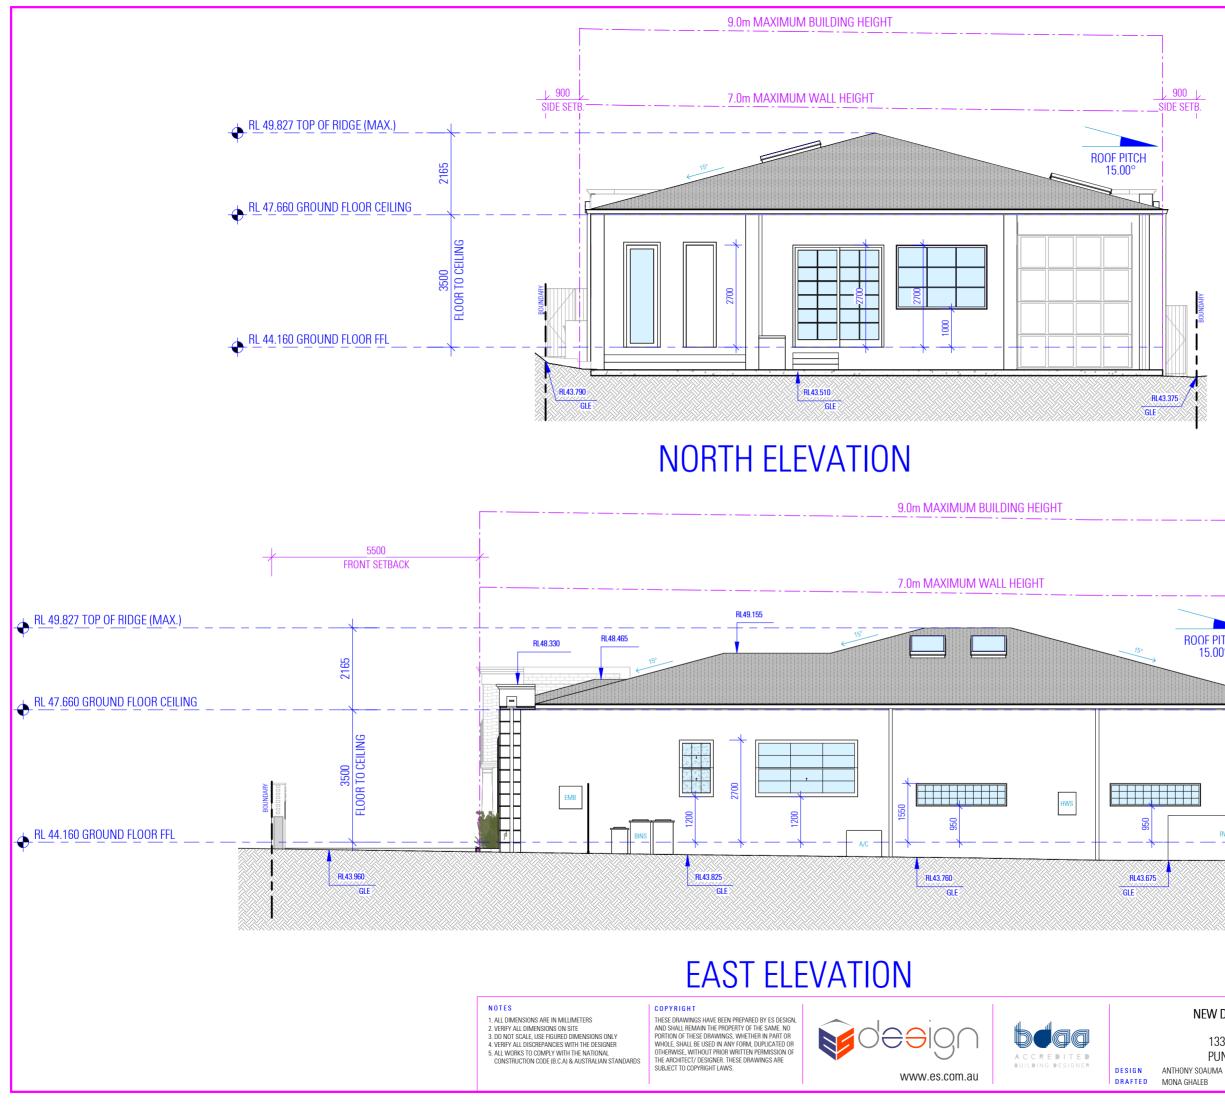
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SOUTH AND WEST ELEVATION

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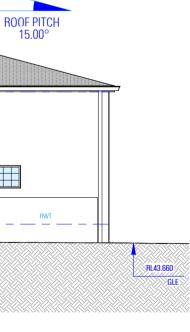
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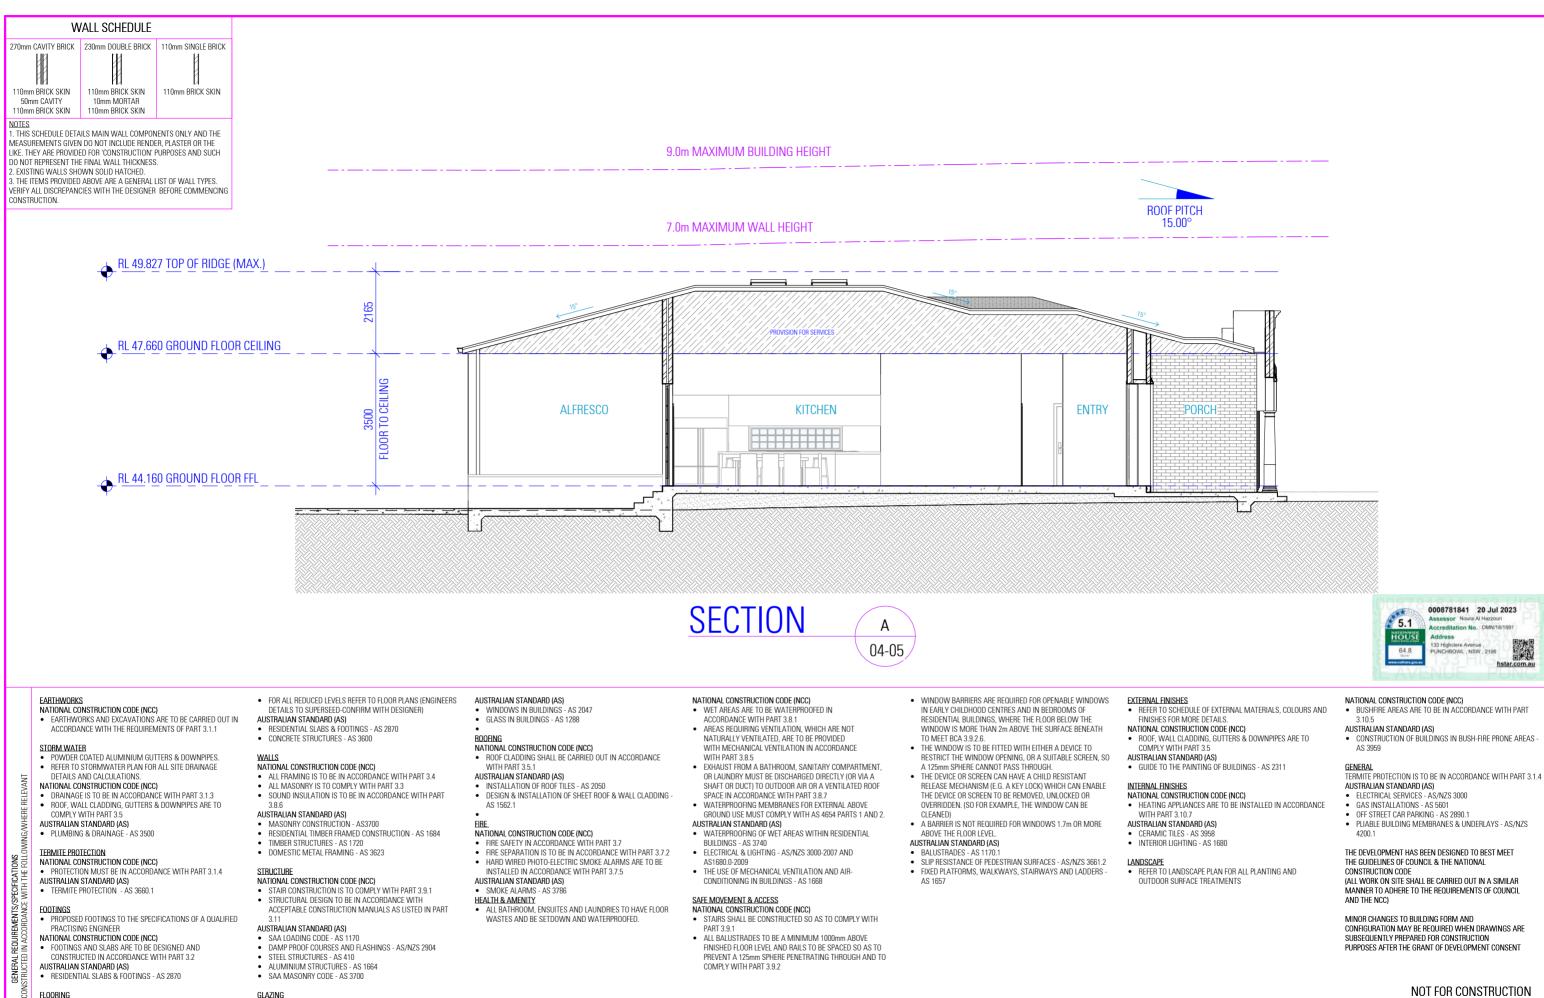
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NORTH AND EAST ELEVATION

Dwg №. 21163 - 07



- PROPOSED FLOOR CONSTRUCTION TO THE SPECIFICATIONS OF
- A QUALIFIED PRACTISING ENGINEER. ALL PORCHES, VERANDAHS & THE LIKE TO HAVE A 85mm STEPDOWN FROM INTERNAL AREAS UNLESS NOTED OTHERWISE

- POWDER COATED ALUMINIUM FRAMED GLASS WINDOWS &
- DOORS LINEESS NOTED OTHERWISE NATIONAL CONSTRUCTION CODE (NCC)
- ALL GLAZING IS TO BE IN ACCORDANCE WITH PART 3.6

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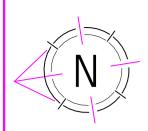
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SECTION VIEW

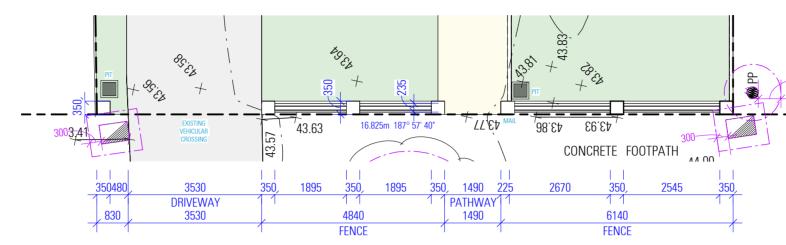
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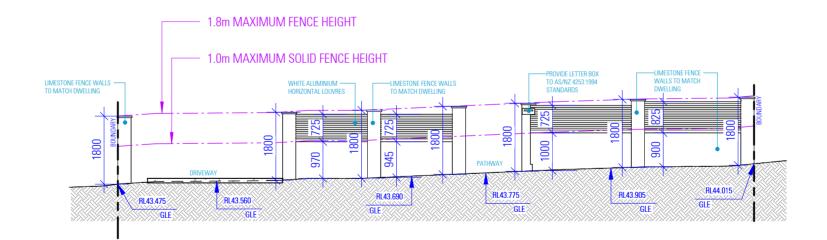
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FRONT FENCE DETAILS



FRONT FENCE PLAN VIEW



FRONT FENCE ELEVATION AS SEEN FROM HIGHCLERE AVENUE

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FRONT FENCE DETAILS

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SCHEDULE OF EXTERNAL MATERIALS, COLOURS AND FINISHES



ROOF TILES RANGE: CONTOUR BORAL CONCRETE COLOUR: CHARCOAL GREY **OR ACCEPTABLE FOUIVALENT**



FRONT ELEVATION EXTERNAL CORNICE RANGE: NATURAL STONE COLOUR: WHITE OR ACCEPTABLE EQUIVALENT



FRIF7F & ARCHITRAVF RANGE: NATURAL POLISHED STONE COLOUR: WHITE OR ACCEPTABLE EQUIVALENT



FRONT ELEVATION TO BE NATURAL LIME STONE **RANGE: HERON / LEBANESE BIC STONE** COLOUR: WHITE OR ACCEPTABLE EQUIVALENT



BULLNOSE TRIM RANGE: NATURAL POLISHED LIMESTONE COLOUR: WHITE OR ACCEPTABLE EQUIVALENT



POLISHED NATURAL LIMESTONE CORNER RANGE: NATURAL POLISHED LIMESTONE COLOUR: WHITE



WHITE PERSPEX GARAGE DOOR RANGE: STEEL LINE SLATTED SECTIONAL ALUMINIUM DOOR COLOUR: SEAMLESS WHITE OR ACCEPTABLE EQUIVALENT



WINDOW WITH A NATURAL STONE TRIM RANGE: POWDER COATED ALUMINIUM COLOUR: OFF WHITE OR ACCEPTABLE EQUIVALENT



FEATURE COLUMN TO BE NATURAL POLISHED LIMESTONE WITH A CROWN AND A BASE AS SHOWN IN THE IMAGE OR ACCEPTABLE EQUIVALENT



ALUMINIUM GUTTERS AND DOWNPIPES 10 RANGE: POWDER COATED ALUMINIUM COLOUR: TERRACE WHITE OR ACCEPTABLE EQUIVALENT



LIMESTONE FENCE WALL & COLUMNS WITH A BULLNOSE CAPPING TO MATCH DWELLING RANGE: NATURAL LIMESTONE COLOUR: WHITE OR ACCEPTABLE EQUIVALENT

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MONA GHALEB



AS SEEN FROM HIGHCLERE AVENUE

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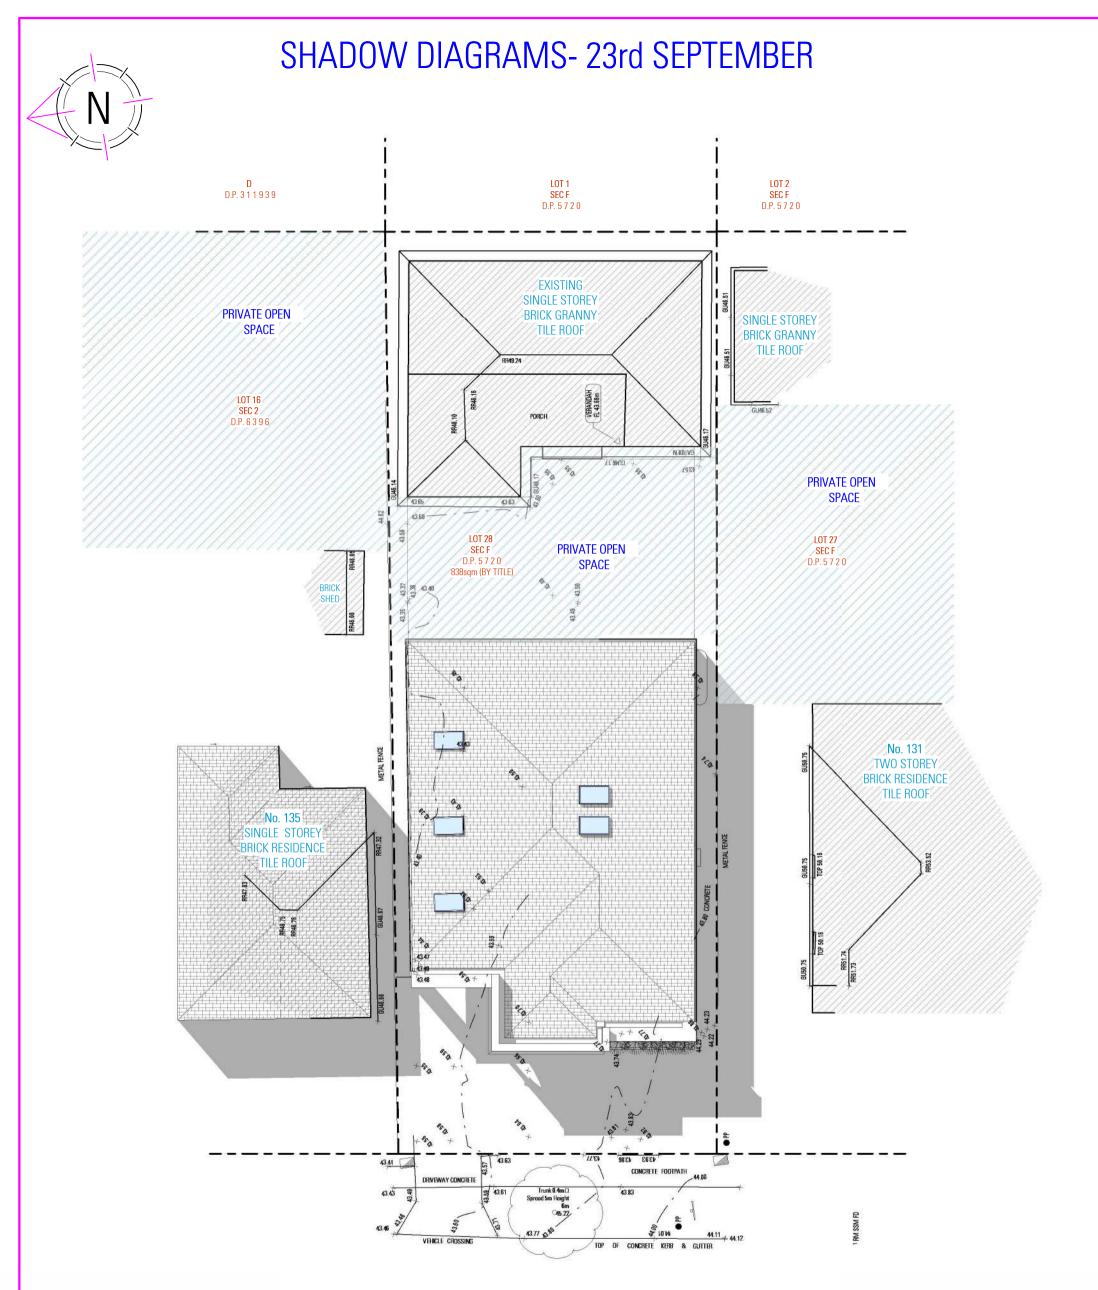
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SCHEDULE OF EXTERNAL MATERIALS, COLOURS AND FINISHES

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HIGHCLERE AVENUE

SHADOW DIAGRAM 9AM

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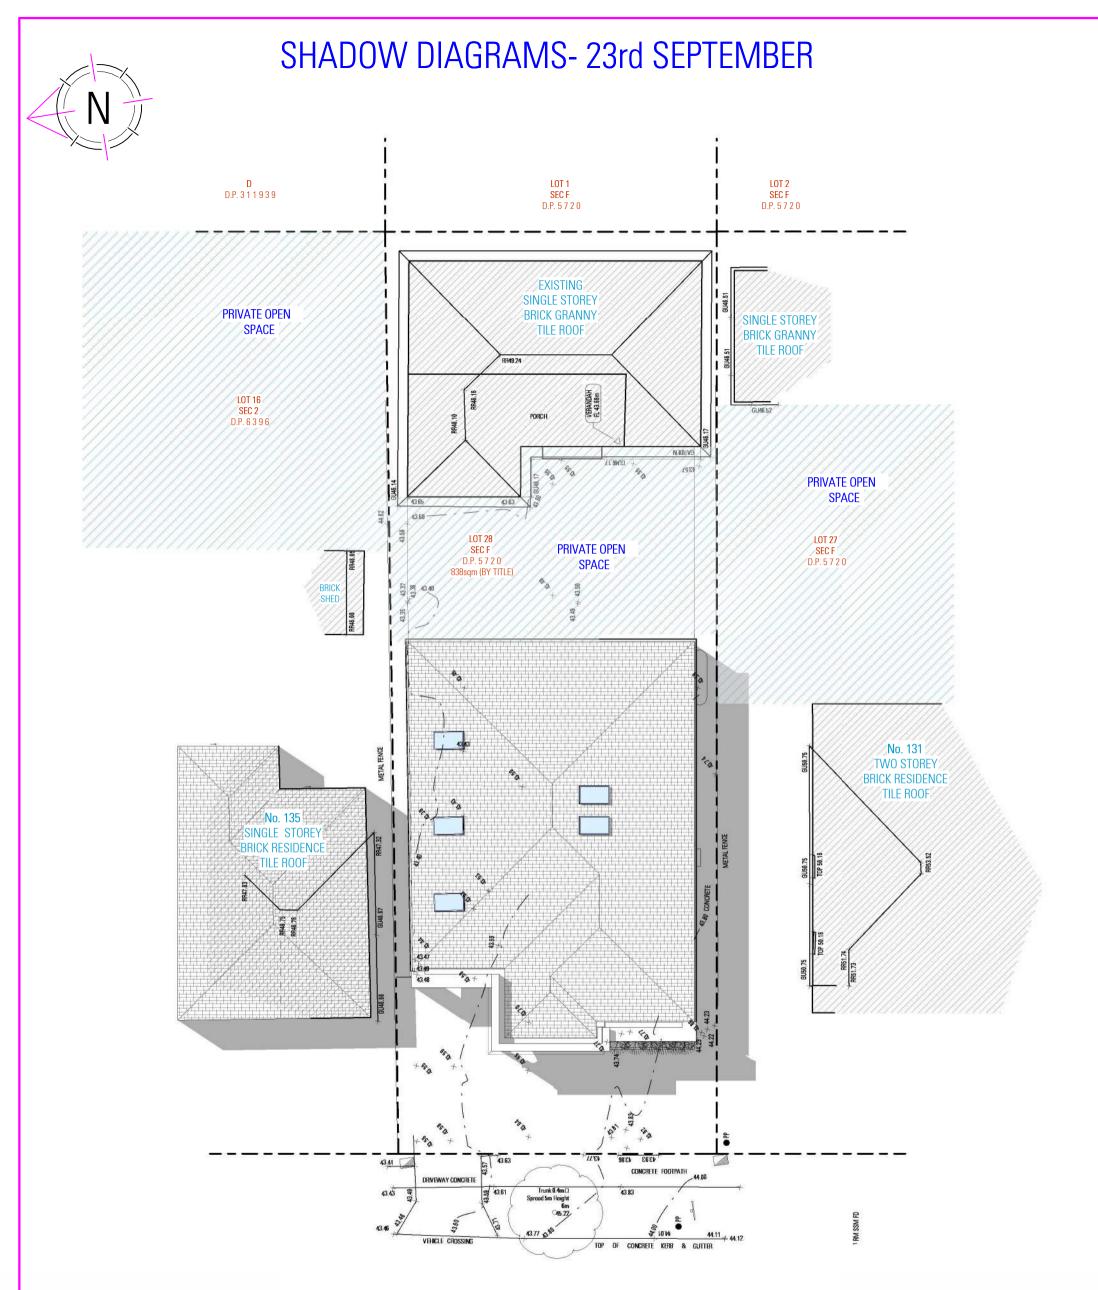
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D	ANTHONY SOAUMA MONA GHALEB	PIERRE AYOUB	SCALE ISSUE	1 : 200 / A3 A 21.09.2023	DWG No. 2



HIGHCLERE AVENUE

SHADOW DIAGRAM 10AM

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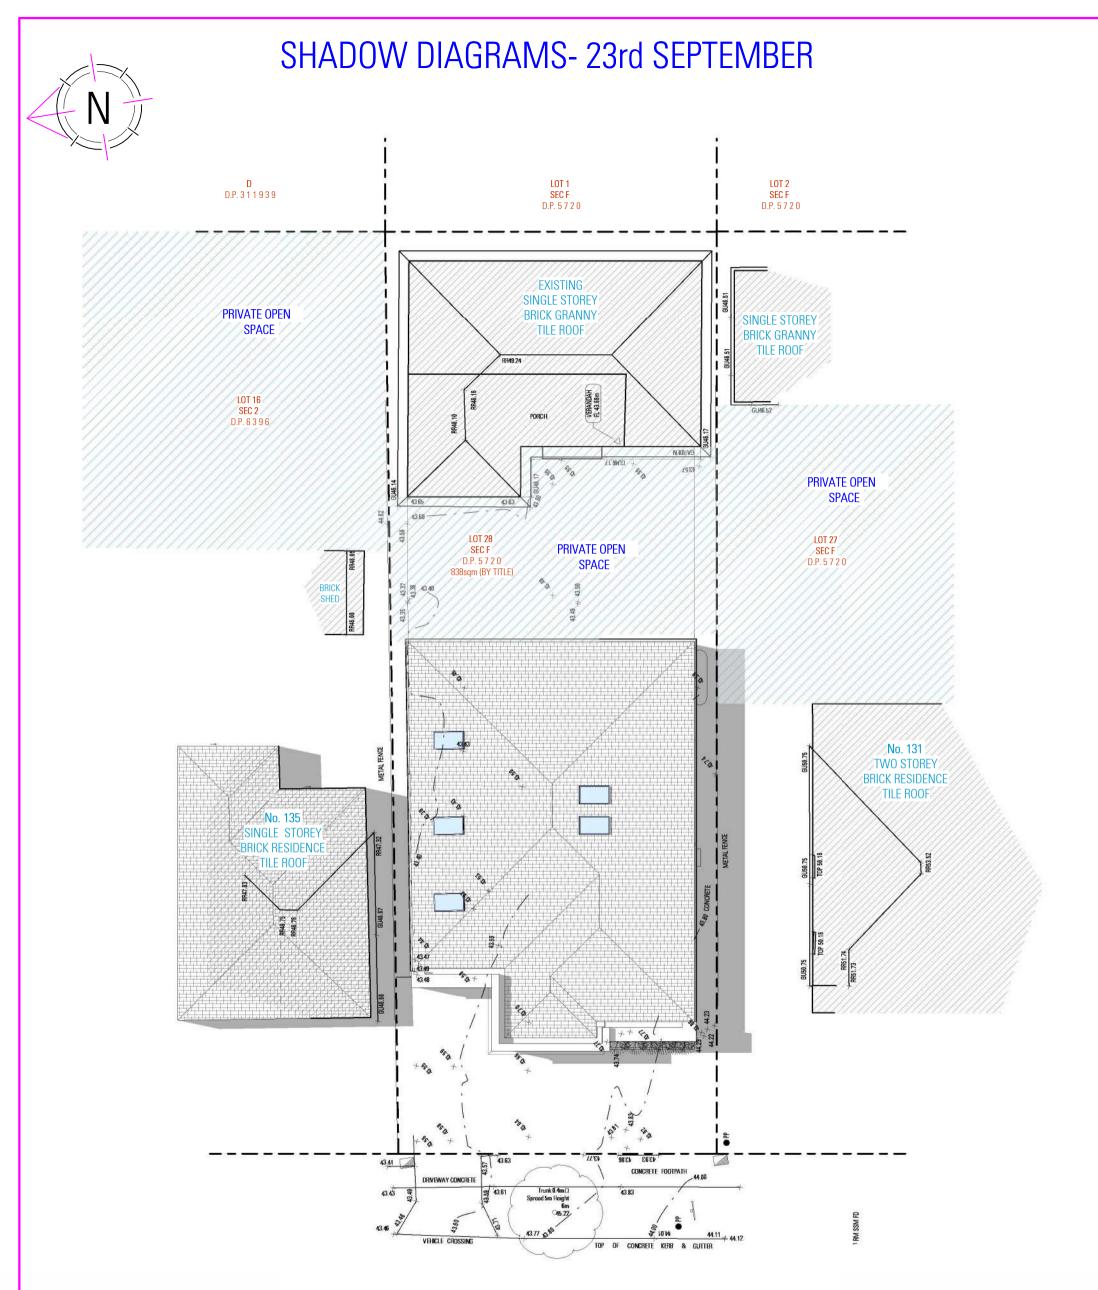
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	ANTHONY SOAUMA		SCALE	1:200 / A3	dwg №. 21163 - 12
D	MONA GHALEB	PIERRE AYOUB	ISSUE	A 21.09.2023	21100 12



HIGHCLERE AVENUE

SHADOW DIAGRAM 11AM

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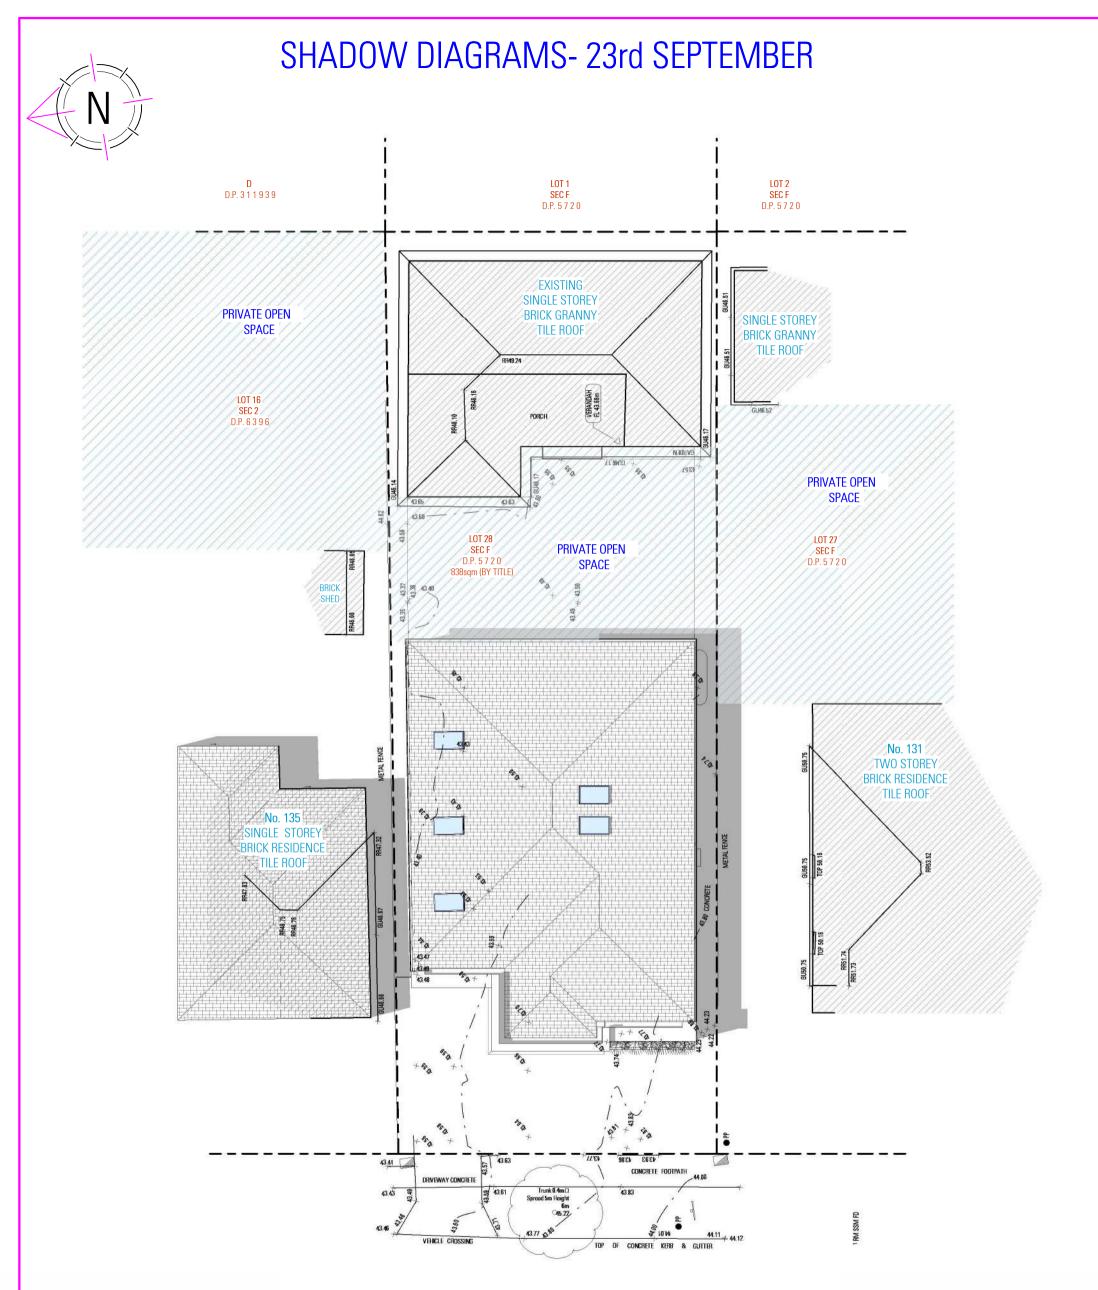




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D	MONA GHALEB	PIERRE AYOUB	ISSUE	A 21.09.2023	Z1103 13



HIGHCLERE AVENUE

SHADOW DIAGRAM 12PM

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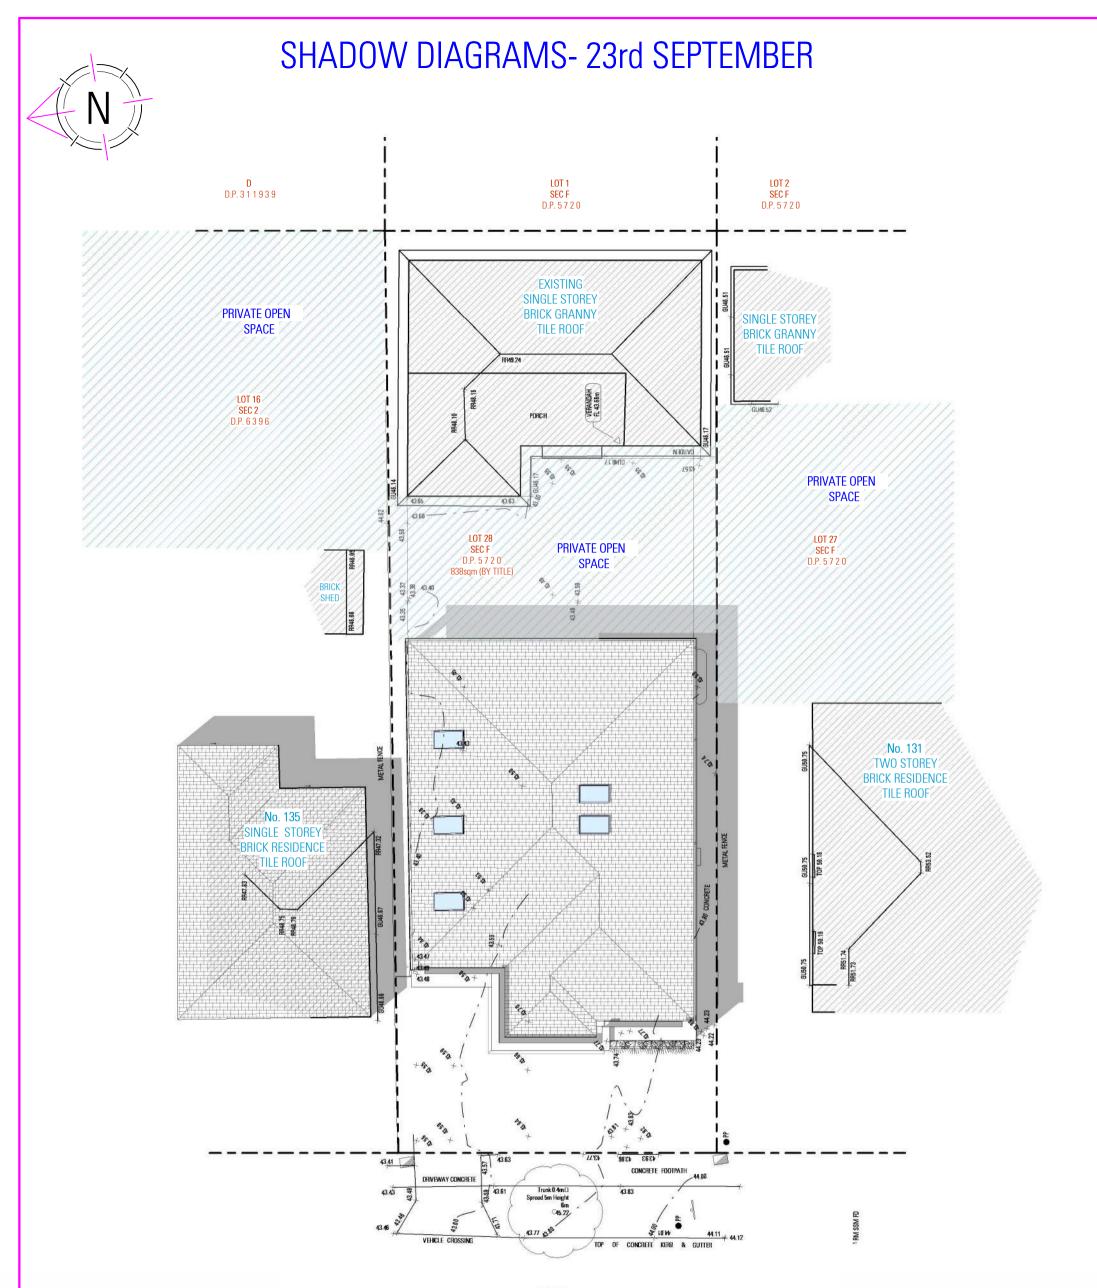
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DESIGN ANTHONY SOAUM DRAFTED MONA GHALEB	IA PIERRE AYOUB	SCALE ISSUE	1 : 200 / A3 A 21.09.2023	dwg no. 21163 - 14



HIGHCLERE AVENUE

SHADOW DIAGRAM 1PM

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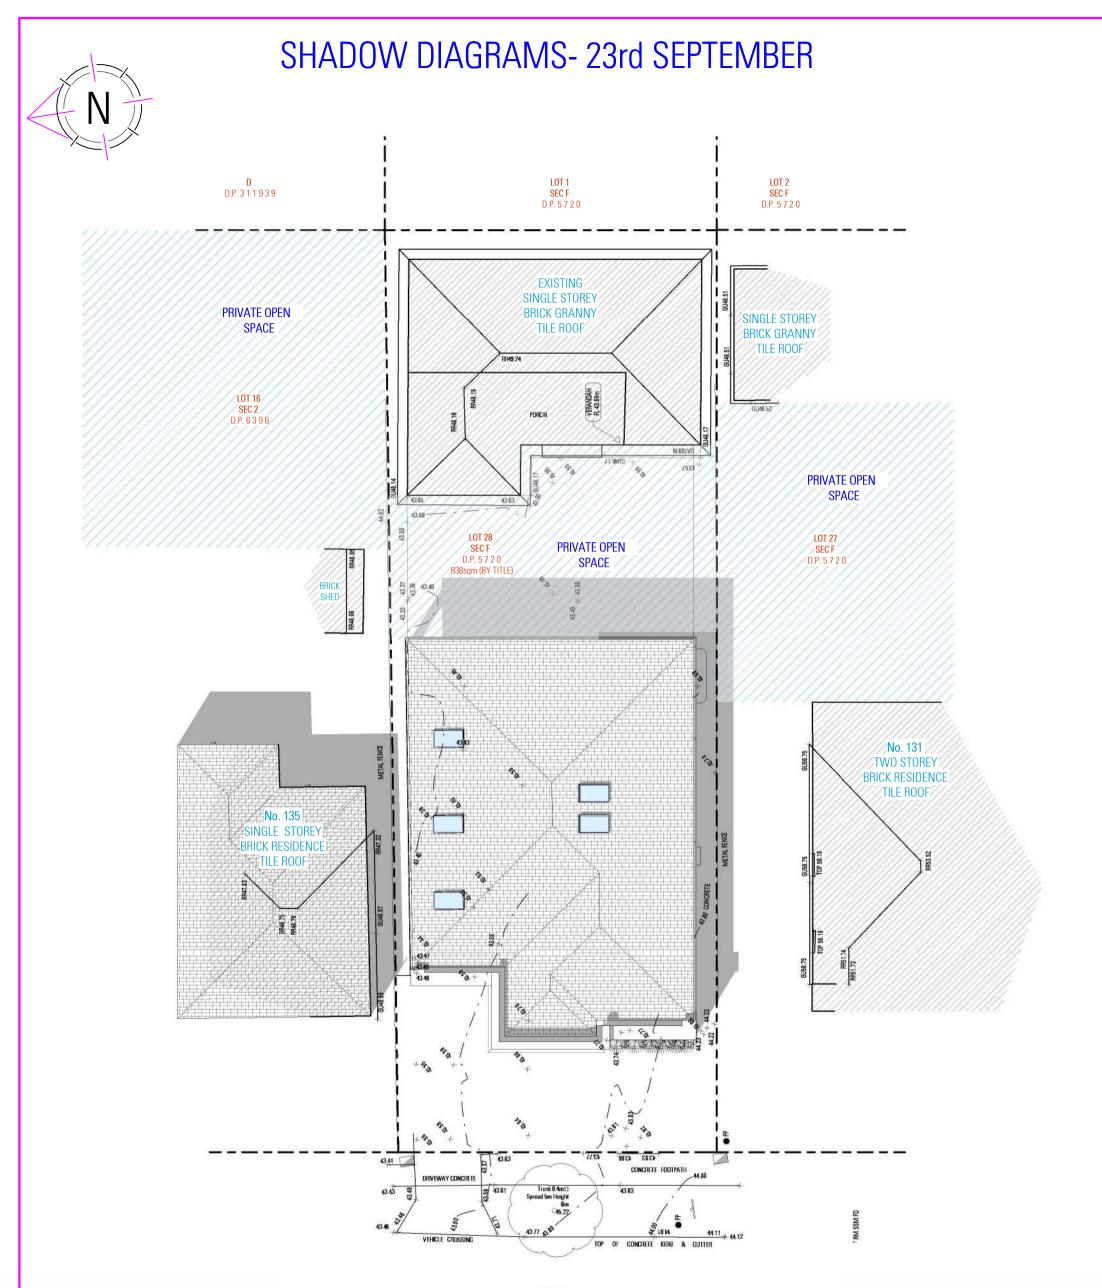
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			SHADO	W DIAGRAM	1 1PM - 23rd
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DESIGN	ANTHONY SOAUMA		SCALE	1:200 / A3	DWG №. 21163 - 15
DRAFTED	MONA GHALEB	PIERRE AYOUB	ISSUE	A 21.09.2023	2110J - 1J



HIGHCLERE AVENUE

SHADOW DIAGRAM 2PM

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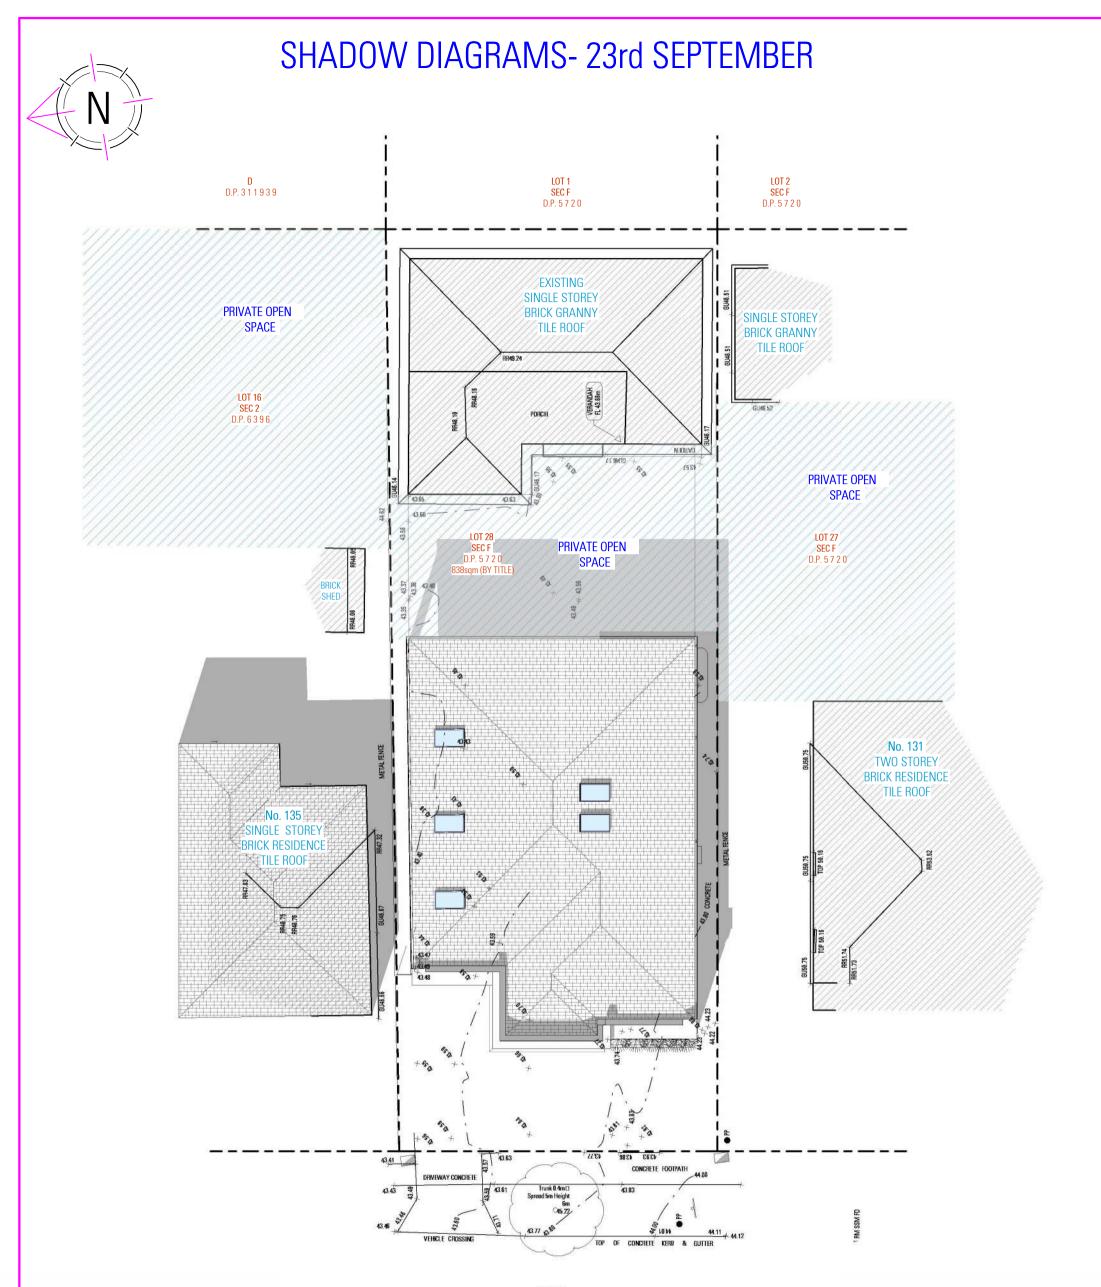
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DESIGN DRAFTED	ANTHONY SOAUMA MONA GHALEB	PIERRE AYOUB	SCALE ISSUE	1 : 200 / A 21.09.2023	^d w g №. 21163 - 16



HIGHCLERE AVENUE

SHADOW DIAGRAM 3PM

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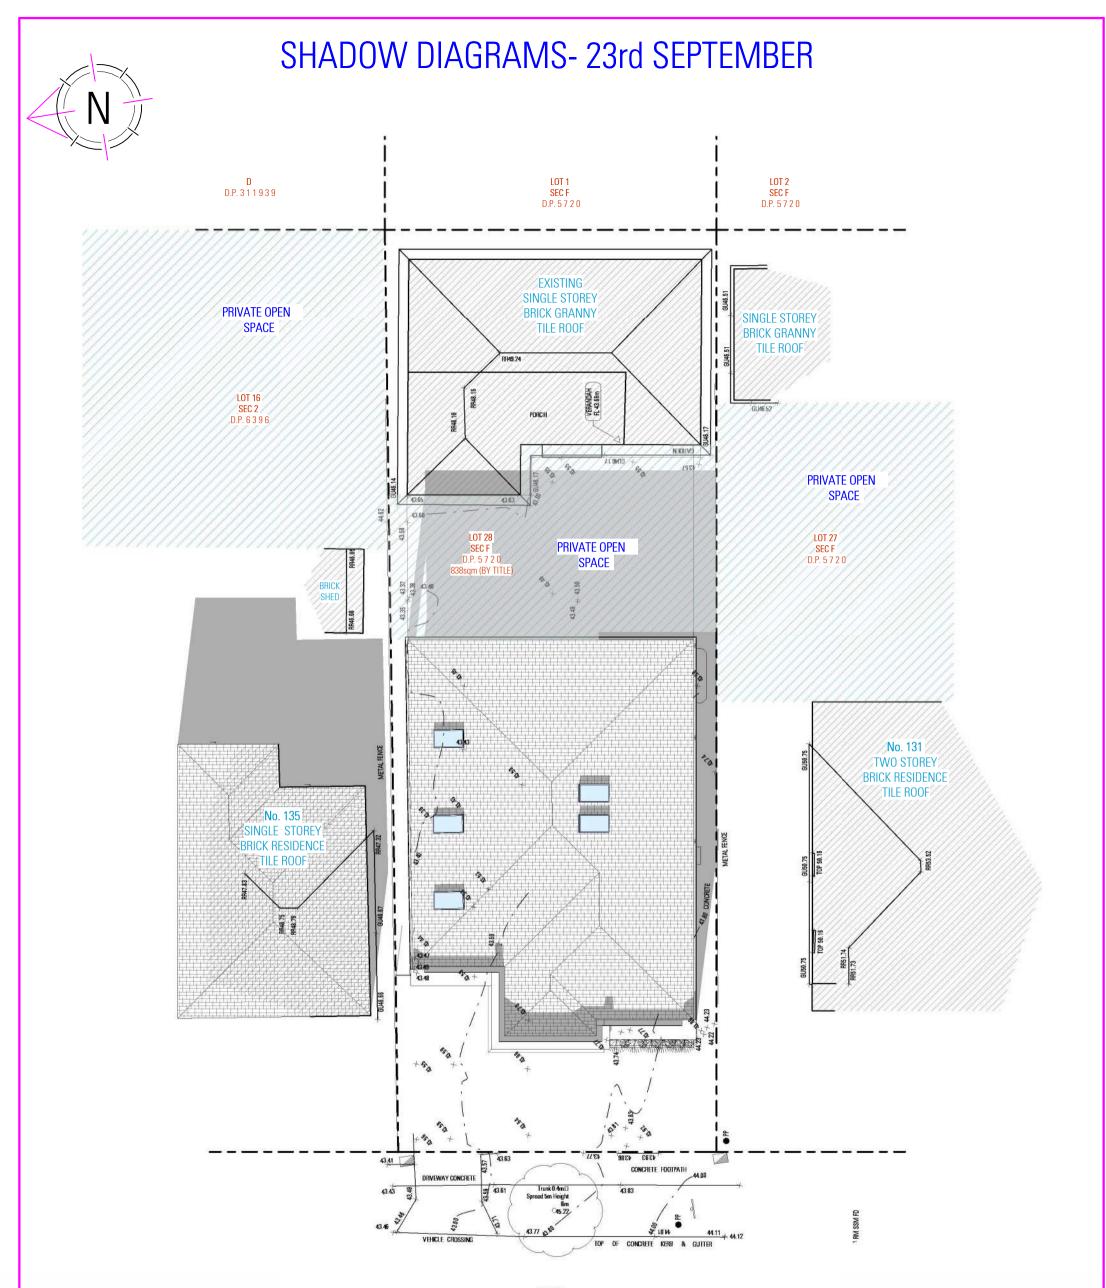
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			SHADO	W DIAGRAM	3PM - 23rd
		LERE AVENUE VL NSW 2196	SEPTEN	MBER	
DESIGN DRAFTED	ANTHONY SOAUMA MONA GHALEB	PIERRE AYOUB	SCALE ISSUE	1 : 200 / A 21.09.2023	dwg №. 21163 - 17



HIGHCLERE AVENUE

SHADOW DIAGRAM 4PM

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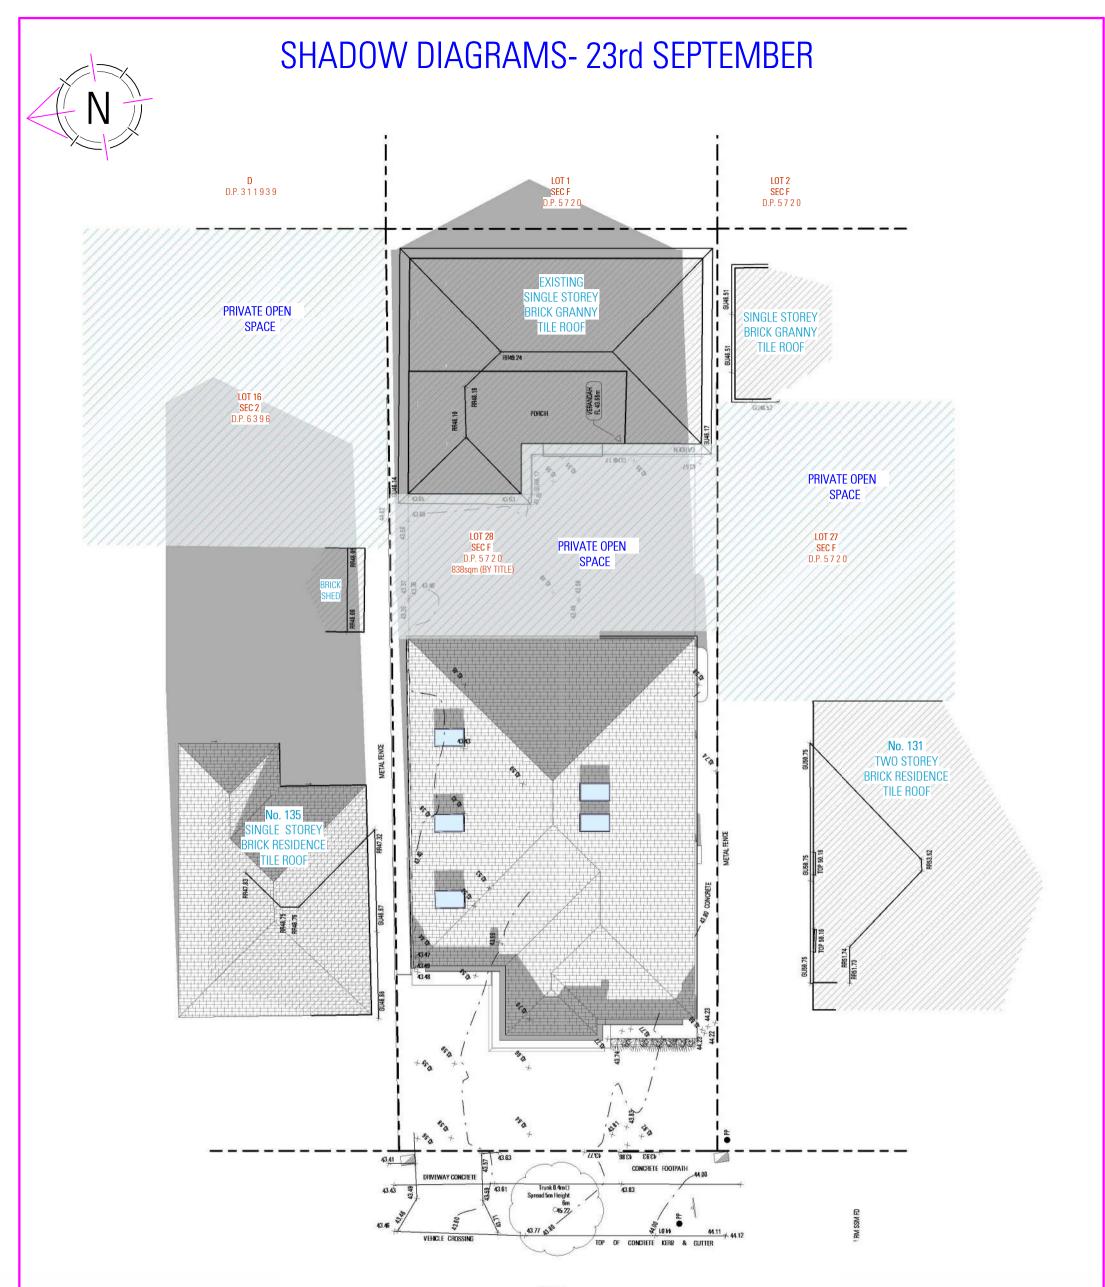
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DESIGN

DRAFTED

Ν	EW DWELLING - SING	LE STOREY	DRAWING			
			SHADO	W DIAGRAM	4PM - 23rd	
	133 HIGHC	LERE AVENUE	SEPTEN	/IBER		
	PUNCHBO\	NL NSW 2196				
	ANTHONY SOAUMA		SCALE	1:200 / A3	DWG No	21163 - 18
	MONA GHALEB	PIERRE AYOUB	ISSUE	A 21.09.2023		21103 10



HIGHCLERE AVENUE

SHADOW DIAGRAM 3PM

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	01	L 0	

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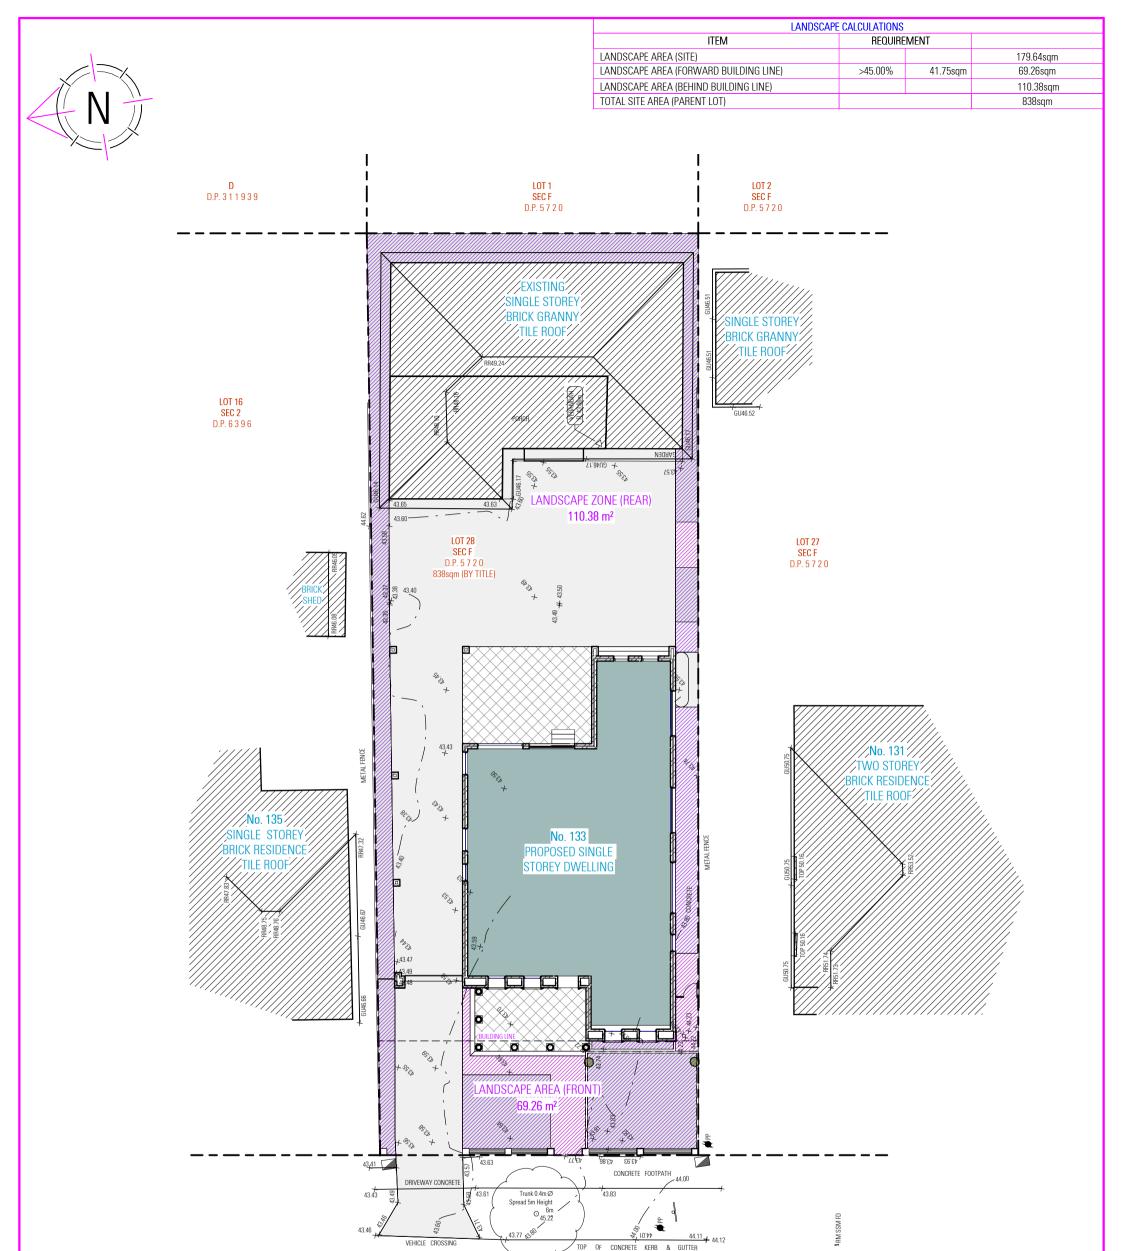
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DESIGN

DRAFTED

NEW DWELLING - SINGLE STOREY		DRAWING	i			
	133 HIGHCLE PUNCHBOWI		SHADO SEPTEN	W DIAGRAM ⁄IBER	l 5PM - 23rd	
D	ANTHONY SOAUMA MONA GHALEB	PIERRE AYOUB	SCALE ISSUE	1 : 200 / A3 A 21.09.2023	DWG No.	21163 - 19





LANDSCAPE AREA CALCULATION PLAN

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Dwg No. 21163 - 20

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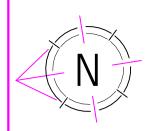


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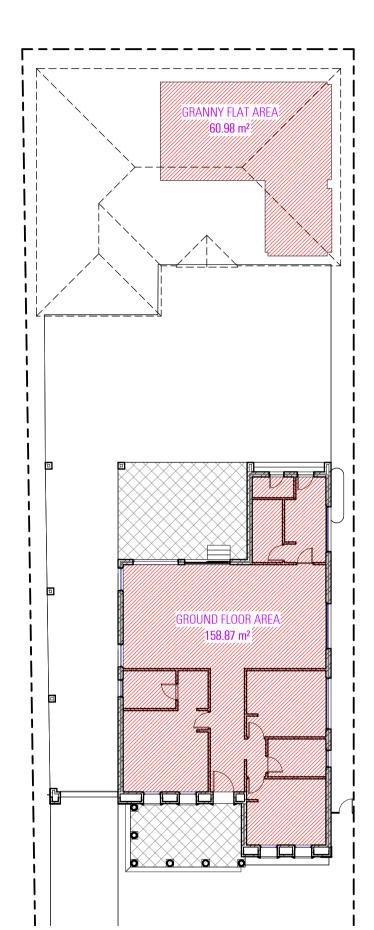
bdaa

N	ew dwelling - :	SINGLE STOREY		^G SCAPE AREA
		IGHCLERE AVENUE HBOWL NSW 2196		, , , , , , , , , , , , , , , , , , ,
DESIGN	ANTHONY SOAUMA		SCALE	1:200 / A3
DRAFTED	MONA GHALEB	PIERRE AYOUB	ISSUE	A 21.09.2023

AREA CALCULATION SHEET



IS
838.00sqm
60.98sqm
158.87sqm
219.85sqm
0.26:1.00
157.25sqm
179.64sqm
0.21:1.00
651.96sqm
0.77:1.00



GROSS FLOOR AREA

600

ACCREDITED BUILDING DESIGNER

DESIGN DRAFTED NOT FOR CONSTRUCTION

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	-	A CALCULATION
SCALE ISSUE	1 : 200 / A3 A 21.09.2023	^d w ^g №. 21163 - 21
	GROSS SHEET	SCALE 1:200 / A3

BASIX COMMITMENTS

BASIX Certificate Building Sustainability Index www.basix.nsw.gov.au

Single Dwelling

Certificate number: 1392784S

This certificate confirms that the proposed development will meet the NSW government's requirements for sustainability. If it is built in accordance will commitments be to before. There used in this certificate, or in the commi-tave the meaning given by the document entitled TASIX Defactors' data (XGR2020 publiced by the Department. The document is available at

Secretary Date of issue: Thursday, 20 July 2020 To be valid, this certificate must be ledged within 3 months of the date of issue



Project name	133_hig			
Street actives	133 Highdere Aver	ue Punchooxi 2196		
Loss Government Area	Canterbury-Bankst	Canterbury-Bankstown Council		
Plan type and plan number	depeated 5720			
Lot ea.	28			
Section no.	Ŧ			
Project type	separate dweiting house			
No. of bedroores	3			
Project score				
Weter	40	Target 40		
Thormal Comfort	V Pass	Target Pass		
Every	¥ 51	Target 50		

Certificate Prepared by	
Name / Company Name: Noura Al Hazzouli	
ABN (// applicable): 80673559711	

Teasta 28 1 5 20

ojoct address		Assessor details and thermal	oads	
ject name	133_hig	Assessor number	OMN/18/1891	
est address	133 Highdere Avenue Punchbowl 2198	Certificate number	0008781841	
cal Government Area	Canterbury-Bankstown Council	Citate zone	56	
an type and plan number	Deposted Plan 5720	Area adjusted cooking load (MJ/m*.ycar)	20	
t no.	29	Area adjusted heating lood (MJ/m*.year)	45	
ction no.	ŧ	Ceiling fan in at least one bedroom	No	
oject type		Celling fain in at least one living room or other conditioned arise	No	
and the	separate dwelling house	Project score		
of backcoms	3	STATUS OF TAXABLE PARTY AND TAXABLE PARTY AND TAXABLE PARTY.	-	_
te dotalis		Woler	✓ 40	Taiget 40
(Tri sera	836	Themai Confort	V Pass	Tanget Page
of area (m²)	307			regio enti
ocitioned floor area (m2)	153.2	Energy	al 51	Terpet 50
conditioned floor area (m2)	9.2	120		
tsi area of gardon and lown (m2)	107			
	Contractor]		

Water Commitments		Show on DA plans	Show on CC/CDC plans & specs	Carts
Fixtures				
The applicant must install show all showers in the development	entreads with a minimum rating of 4 star (> 4.5 but \Leftrightarrow 5 L/min plus spray force and/or coverage tests) in		~	
The applicant must install a toil	el flueting system with a minimum rolling of 4 star in each toilat in the development.		~	
The applicant must install tops	with a minimum rating of 5 star in the kitchen in the development.		~	
The applicant must install begin	taps with a minimum rating of 5 star in each bathroom in the development.		~	
Alternative water				
Rainwator tank				
	water tank of all least. 1500 litres on the site. This rainwater tank must meet, and be installed in rifs of all applicable regulatory authorities.	~	~	
	e remoter task to collect rein runoff from at least 50 square metres of the roof area of the development which drains to any stormwater tank or private dam).		~	
The applicant must connect the	nainwater lank to:			
 all tollets in the development 	e		~	
 at least one outdoor tap in the consumption in areas with 	he development (Noto: NSW Health does not recommend that rainwater be used for human potatile water supply)		~	
				-

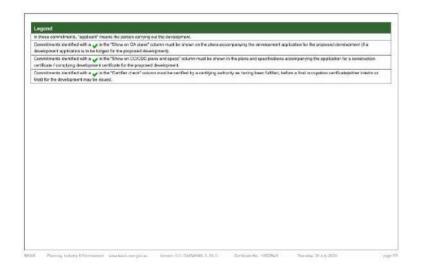
The spectram rule data in the conflate information users Nameseo Details on the Nampage of Its DADC certification (or Nameseo) Consistents in the Analysis of the account of the Conflate Information of the Nameseo Details of the Nameseo Details of the Its spectral field in the spectral	Thermal Comfort Commitments		Show on DA plane	Show on CC.CDC plans & space	Certifier chack
Flast and real sensitivities	Simulation Method				
The decail of the proposed development on the Assess Cardificate must be construct with the evolution in the ASSIS.	Cettificate") to the development application and construction certificate app applying for a complying development certificate for the proposed development	plication for the proposed development (or, if the applicant is ment, to that application). The applicant must also attach the			
certificate, mudiafa the Caking and Heating tools shown on the first gast of this certificate. The exclusion rule in the one of the gas exception privity the development application the proposed ferring trends. If earlies which the Assesser Carlindon for any gas exception privity the development application the proposed ferring trends. If earlies which the Assesser Carlindon for any gas exception of the privile application or any gas exception of the privile application of t	The Assessor Certificate must have been based by an Accted bid Assess	or in accordance with the Thermal Comfort Protocol.	8		1
Accession: Certificate majoria to be inverted in the site parts. These place mails bear a stamp of exclosement from the Accession Resement in certificity that is the care. The application and allows in the place accession place accessed to the accession of the					
Certificial and in accordance with how expects of the development application or application for a conclusing development certificate with how expects and available these expectisions.	Assessor Certificate requires to be shown on those plane. Those plane ma Assessor to certify that this is the case. The applicant must show on the pla- cartificate (or complaing development certificate. If application), all thermall	at beer a stamp of endorsement from the Accredited ans accompanying the application for a construction performance specifications set out in the Accessor		~	~
Flaer and wall construction Area	Certificate, and in accordance with those aspects of the development appli	nai performance specifications set out in the Assessor loaden or application for a complying development certificate		~	~
	The applicant must construct the floors and walls of the dwelling in accorde	ance with the specifications listed in the table below.	-	~	~
Ilor - suspendet Rosrienciosed subhor: All er part of floor avea aquain memos	Floor and wall construction	Arm			
	Toor - suspended floortenclosed subfloor	All or part of floor area aquare metres			
		MONTH O'CO			

10.0 0.00

Commerce May 1992284-9

Energy Commitments	Show on DA piano	Show on CC/CDC plans & space	Certifier chack
Hot water			
The applicant must install the following hot water system in the development, or a system with a higher energy rating gas instantaneous with a performance of 3 stars.	~	~	~
Cooling system			
The applicant must install the following oceaing system, or a system with a higher energy rating, in at least 1 living area; 1-phase enconditioning. Energy rating: 3 ster (enverage zone)		~	~
The applicant must install the following cooling system, or a system with a higher energy rating, in at least 1 bedroom: 1-phase arconditioning: Energy rating: 3 star (average zond)		~	~
Heating system			
The applicant must restail the Kilowing healing system, or a system with a higher energy rating, in at licest 1 tiving area; 1-prices accorditioning, Energy rating: 3 star (everage zons)		~	~
The applicant must install the following heating system, or a system with a higher energy rating, in at loss! 1 bodroom. 1-phase anonoditioning: Energy rating: 3 star (average zono)		~	~
Ventilation			
The applicant must install the following exhaust systems in the development:	1		1
Alleast 1 Battecom individual fan, not ducked, Operation control: interlocked to light		~	~
Kitchen: individual fan, not ducted: Operation control: manual awirch on/off		~	
Laundry: individual San, not ducties; Operation control intertocked to kg/k		~	
Artificial lighting			
The applicant must ensure that the "primary type of antifold lighting" is fluctnescent or light emitting diode (LED) lighting in each of the following rooms, and where the word "defaulted" appears. Its fittings for those lights must only be capable of accepting flucenceant or light emitting doub LED) largue.			
 at least 3 of the bidrooms I study; dedicated 			
 al least 2 of the living I diving rooms; dedcated 			
		~	~
Packitcher, dedicated			

	y Commitments
• alb	athreomotiolists declated
• Del	laundry dedicated
• all	allways; decicoted
Natura	al lighting
The app	clicant must install a window and/or skylight in the
The ag	Acant must install a window and/or skylight in 21
Other	8
The arts	clicant must install a gas conktop & electric over
The app	olicent must install a fixed outdoor clothes drying



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	Show on DA plane	Show on CC/CDC plans & specs	Certifier chock
		~	v
		~	~
		~	~
the dwolling for natural lighting.		1	
	~	~	4
)holet(s) in the development for natural lighting.	~	~	~
en of the dwelling,		~	1
of the development.		~	

NOT FOR CONSTRUCTION

DRAWING NEW DWELLING - SINGLE STOREY 133 HIGHCLERE AVENUE PUNCHBOWL NSW 2196 SCALE PIERRE AYOUB ISSUE A 21.09.2023

/ A3

^{dwg} №. 21163 - 22

NATHERS COMMITMENTS

		ate No. 0008781841	5	1 24
Actionation on 2	9 JUI 2023 US	ang bene Pie vent au (a.e.i)	the second	and they are the second
roperty			NATIO	NWIDE
ddress		33 Highdere Avenue , PUNCHBOWL, NSW		LISE
obDP	2	8/5720	ENERGY RAT	TING SCHEME
ICC Class*		1 IN IOLIDIO		
Уре	N	lex Owelling	64.	B MJ/m ²
Plans			testig accord	Angel of standard
Nain plan	_ 0	8523	for room	formation pri
repared by	E I	S Design		hers.gov.au
Constructio	on and en	wironment	XL-AV	
asessed floor		Exposure type	Thermal per	
andfioned*	149.0	Seburbish	Heating	Cooling
Inconditioned*	9.0	NatHERS climate zone	45.3	19.6
lotat	157.0	56	MJ/m ²	MJ/m ²
Sarage	0.0			
Accri Iame Iusiness name Imail	editod as	SOSSOF Noura Al Hazzouri rome roura h@optusnet.com.au	thermal energy load about the design as and common patter The software does	models the expected datusing information and construction, climate mis of household use not take into account on the sinflow impacts
hone		0405800 600	from ceiling take.	
locreditation N		DMN/18/19D1	Verification	
issessor Accre		lisation	To verify this	
Design Matters National Declaration of Interest				ienenste?
			p=wtqSipide When using either visiting hater com a	ink, ensure you are Is
ational Constru	ction Code (N			
e delaikid in JC.2 ar	nd 15 is 38 of the			
arbrierts through th	to NatifiRS and	ate manune car nitings and separate healing and coo econert. Requirements additional to be Natilia S acc ds, thermal brooks, building assing, water heating and	economi that must also be called	ed include, but are not

002701041 NatHER	o contractor			r Rating on of 20 Jul	ever	14.01
Location	Wall ID	Height (mm)	Width (mm)	Orientation	Horizontal shading feature" maximum projection (mm)	Vertical shading feature (yesino)
Kitchen/Lising	EW-1	3500	6850		0000	YES
Kitchen/Living	EW-1	3500	3540	8	350	NO
Kitcheo'Lixing	EW-1	3500	1840	W	2750	YES
butiers kit	EW41	3500	1595	E	1000	NO
bullers kit	EW-1	3500	4995	a	360	NO
Idry	EW-1	3500	3390	N	7150	YES
We	EW-1	3500	1096	N	7160	NO
We	EW-1	3500	2195	E.	1000	NO

Internal wall type

Wall ID	Wall type	Area (m ²)	Bulk insulation
IW-1 - Single Skin Brick		168.00	No insulation

Floor type

Location	Construction	Area Sub-floor (m ²) ventilation	Added insulation (R-value)	Covering
Bedroom 2	Wafte pod slab 300 mm 100mm	16.10 None	Watte Pod 300mm	Ceramic Tiles 8mm
hath	Waffe pod stab 300 mm 100mm	#.20 None	Walte Pod 300mm	Ceramic Tiles &mm
Bedroom 3	Waffie pod stab 300 mm 100mm	15.50 None	Walle Pod 300mm	Ceramic Tiles Smm
Master Bedroom	Waffle pod slab 300 mm 100erm	19.00 None	Wafte Pod S00mm	Ceransic Tiles & min
ens	Weills pod slab 360 mm 100mm	5.83 None	Walte Pod 300mm	Ceterror Tiles Smm
We	Concrete Stab on Ground 100mm	3.50 None	No Insulation	Ceremic Tiles Serm
Kitchon'Living	Weifie pod elab 300 mm 100mm	74,50 None	Waffe Fod 300mm	Ceremic Tiles Brim
butiers kit	Woffle pod slab 300 mm 100mm	9.50 None	Watte Pod 300mm	Ceremic Tiles Smm
Idry	Wafflo pod slab 300 mm 100mm	6.20 None	Wafte Pod 300mm	Coramic Tiles 8mm
We	Waffle pod slab 300 mm 100mm	2.40 None	Walte Pod 300mm	Ceramic Tiles Serm

	Ceremic Friesemm	wate Pop Scorm	74,50 NORE	200 mm Journa
No Data A	Ceremic Tiles Serm	Walts Pod 300mm	9.50 None	300 mm 100mm
	Ceramic Tiles 8mm	Wafte Pod 300mm	6.20 None	300 mm 100mm
Roof ty	Certarnic Tiles Brinn	Walte Pod 300mm	2.40 None	300 mm 100mm
Construc				
Roof Tiles				

Telefold (deceary) Constrained on 20 Ad 2022 using 3CRS Provel 4.1 Set (2.21) for 102 Higheless Avenue. PUACHECIM., NEW, 2156

6082701041 NathERS Cortificate	5 1 Stor Rading on of 20 Jul 2023	
Certificate check		
	then built as per the NatHERS Certificate. While you need to heak covers some important items impacting the dwelling's r	

Does this Certificate match the one evolubils at the web extenses or QR code in the verification box on the front page? Does the set of NatirERS-stamped plans for the dwelling have a Certificate number on the stamp that matches this Certificate? Celling percentations*

Dose the 'number' and type' of calling penetrations (e.g. downlights, exhaust lone, etc) shown on the stamped plane or installed, match what is shown in the Centricate? Windows

Does the installed whickew meet the subsitution tokerances (SHOC and U-value) and vencov type, of the window shown on the Certificate? Subsituted values must be based on the Avairatian Fenesization Rating Council (AFRC) protocol. chuect entrance chors.

Apartment contance drows Diese the "Determal Door Solnduke" shaw apartment entrance devers? "Please note that an "external door" between the m develing and a stand space, such as an enclosed someter or flyory, cheatri not be included in the ecoescentrek (because overstates the possible vertification) and would invalidate the ContReate.

Exposure*

Cuprovate Has the appropriate account level (terrar) been appled? For example, it is unlevely that a ground-files apartment is "acposed" or a top foor right-res opartment is "protected". Providence? values Have provisional values been used in the assessment and, if so, noted in "additional notes" below?

Additional notes

I have modeled the shading in accordence with NatHERS principles

Window and glazed door type and performance

Window ID	Window	Maximum	SHOC*	Substitution to	lerance ranges
Window ID	Description	U-value*	SHOC.	SHGC lower limit	SHGC upper limit
ALM-001-01 A	ALM-001-01 A	87	0.57	0.54	0.60
at and include	Aluminium A SG Clear	dare.	0.37	0.34	0.00
ALM-062-01 A	ALM-002-01 A	87	0.70	0.96	0.73
ALM-UUZ-US A	Akminium B SG Clear	0.7	0.70	0.00	0.73

Custom" windows

Window ID Window Description Maximum SHGC* Substitution tolerance ranges U-value* SHGC lower limit SHGC upper limit No Data Available

Window and plazed door schedule

Location Window Window Height Width Window Opening Grientation hading endormed with the station of the station * Refer to glossery Generaled on 20 Jul 2022 using 3ERS Provel 4.1.6c (2.21) for 102 High-low Avanue PUACI &COM, NSW 2196

008791641 NathERS 0	JorfiScate \$	t Ster Rading on of 20 Jul 2023	
Location	Construction material/type	Bulk insulation R-value (may include edge batt values)	Reflective wrap*
Bedroom 2	Ptisterboard	Bulk Insuation R3.5	No
hath	Plasterboard	Bulk Instation R3.5	No
Bedioon: 3	Plasterboard	Bulk Insulation R3.5	No
Mastar Bedroom	Plesterboard	Bulk Insulation R3.5	No
ens	Plastarboard	Bulk Insulation R3.5	No
Wir	Plasterboard	Bulk Insulation R3.5	Na
Kitchan'Living	Plastorboard	Bulk Insulation R3.5	No
butters kit	Plasterboard	Bulk Insulation R3.6	No
læy	Platerboard	Bulk Insulation R3.5	Nig
Wic	Plasterboard	Bulk Insulation R3.5	No

Ceiling penetrations*

Location	Quantity	Туре	Diameter (mm)	Sealed/unsealed
Bodroom 2	a	Downlights - LED	153	Sealed
Bedroom 3	4	Downlights - LED	190	Saster
Master Bedroom	- 4	Downlights - LED	150	Seakd
Ktchen/Living	0	Downlights + LED	150	Sealed
Kitchen/Living	4	Exhaust Fares	300	Senied
Idry	1	Exhaust Fans	300	Sealed
<u></u>		CHICATAG		
Ceiling fans		Quantity	97D:	neter (mm)
Ceiling fans			97D:	
Ceiling fans Location No Data Available Roof type			97D:	

Foil, Gap Above, Reflective Side Down, Anti-giaro Up 0.85 Dark

* Refer to globality Generated on 20 Jul 2021 using SERE-Proved A 1.54 (3.21) for YS3 Highsion Avenue. PLACEGOWL, NEW , 2156 Page 0 a

0082704044 NathE	Cortificate	5.1 91	or Rating oc	of 20 Jul 2	1923			
Location	Window ID	Window no.	Height (mm)	Width (mm)	Window type	w Opening	Orientation	Window shading device"
Bedroom 2	ALM-061-01 A	nip	3000	900	914	45	w	No
Badroom 2	ALM-001-01 A	n 🖘	3093	900	nia	45	w	No
batt	ALM-002-01 A	aie .	1500	900	89	45	s	NO
Bedroom 3	ALM-062-01 A	nia.	1500	2700	154	45	s	No
Master Bedroom	ALM-001-01 A	nia	3033	900	nie	41	w	No
Mester Bedroom	ALM-001-01 A	sie .	3000	900	nie	45	w	No
685	ALM-002-01 A	nia	1500	902	nie.	45	N	No
Kitchen'Living	ALM-002-01 A	nia	3000	1200	nia	45	N	No
Ktchan'Lwing	ALM-002-01 A	nia .	3000	1200	Nis	45	N	No
Kitchen'Living	ALM-802-01 A	nia.	3000	2410	nia	46	E	No
Ktchen'Living	ALM-0E2-01 A	11.0	1700	2410	nis	45	E	No
Kitchen'Living	ALM-002-01 A	n.ia	600	2400	nia	.45	5	No
Kitchen/Living	ALM-001-01 A	nia	3000	1200	818	90	w	NO
tuters kt	ALM-601-01 A	nia.	2700	820	ilia	100	E	NO
tuties kit	ALM-002-01 A	ncia	000	2400	nia	45	5	No
Roof windo Default* roof	w type and p windows	erformar	nce					
	Window Description		wimum -value*	SH	GC*	Substitut SHGC lower l	ion tolerance limit SHGC	
No Data Available								
Custom* roo	fwindows							
	Mindow Description		value"	SH	GC.	Substitut SHGC lower l	ion tolerance limit SHGC	ranges upper limit
No Deta Available								

Location Window Window Opening Height Wildh Orientation Outdoor Indoor shade shade No Dela Available

Hole to gassery Generated on 20 all 2022 using BERS Pro vil 4.1.64 (2.21) for 102 High-loss Avenue. PUACH 60145, NEW 2166

Skylight type and performance

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NOTES

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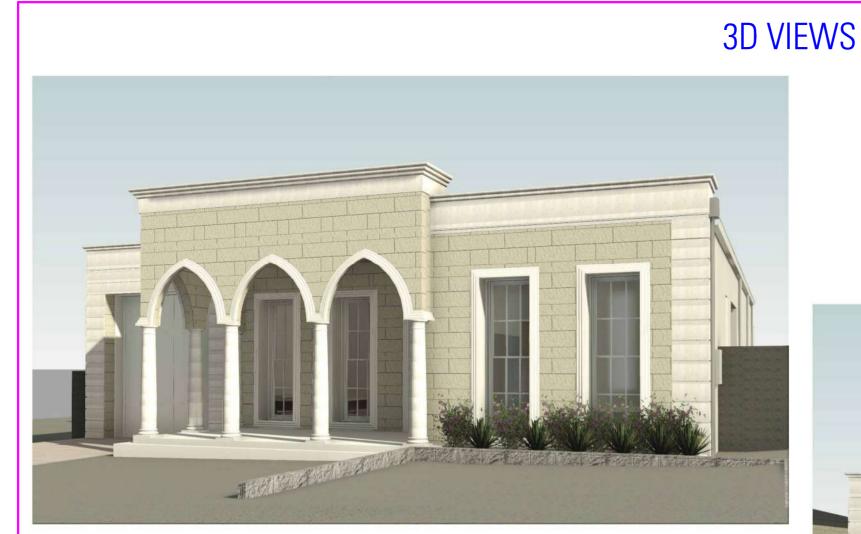
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